

1 Centre Street 9th Floor North New York, NY 10007 Voice (212)-669-7700 Fax (212)-669-7960 http://nyc.gov/landmarks

STAFF USE ONLY

LPC DOCKET #: 19-12195

DATE RECEIVED:

STAFF:

ACTION: PMW

CNE COFA REPORT OTHER:

WORK TYPE:

#### APPLICATION FORM FOR WORK ON DESIGNATED PROPERTIES

#### **INSTRUCTIONS FOR FILING**

A complete application includes this form ("Application Form") and materials needed to describe the project and its effect on the landmark property. Please read the instructions of this form carefully, and provide all the information requested for ALL 6 sections. LPC staff uses this information to determine if the application meets LPC's rules for approval by staff or will require a review by the full Commission at a Public Hearing. Failure to submit complete applications with required materials will result in delays in the review and processing of your application. Filing may be done in person or by mail to the address above.

ADDRESS: 225 East 5th Street BOROUGH: Manhattan  2. PROPOSED WORK (CHECK ALL THAT INTERIOR ALTERATIONS  RESTORATION & OTHER FAÇADE WOR HEATING, VENTILATION & AIR CONDITION EQUIPMENT  WINDOW & DOOR WORK  ADDITIONS & NEW CONSTRUCTION  STOREFRONTS  EXCAVATIONS, SIDEWALKS AND SITEM	IN   PL   PL     K	ECREATE MISSING ARCHITED XTERIOR REPAIRS (check all the street façade  Side or rear HRU-WINDOW/LOUVERS & OT Street façade  Rear or side factorized factori	nat apply): r façade/roof		
NTERIOR ALTERATIONS  RESTORATION & OTHER FAÇADE WORK  HEATING, VENTILATION & AIR CONDITION  EQUIPMENT  WINDOW & DOOR WORK  ADDITIONS & NEW CONSTRUCTION  STOREFRONTS	IN   PL   PL     K	LACE OF ASSEMBLY/CERTIFICE ECREATE MISSING ARCHITEC XTERIOR REPAIRS (check all the street façade  Side or rear HRU-WINDOW/LOUVERS & OT Street façade  Rear or side fact HRU-WALL HVAC EQUIPMENT THER MECHANICAL EQUIPME EPLACE WINDOWS (check all the street-facing façade/s  Rear EW/MODIFY WINDOW OPENING Street-facing façade/s  Rear EPLACE DOOR(S) or MODIFY IN EW BUILDING	CATE OF OCCUPANCY/ NO WORK PROPOSED  CTURAL FEATURES nat apply): r façade/roof		
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ADDITIONS & NEW CONSTRUCTION		Street-facing façade/s ☐ Real EW/MODIFY WINDOW OPENIN Street-facing façade/s ☐ Real EPLACE DOOR(S) or MODIFY I EW BUILDING	r or side non-street facing façade IG(S) (check all that apply): ar or side non-street facing façade		
TOREFRONTS					
	□ RE	□ NEW BUILDING □ ROOFTOP ADDITION (check all that apply): □ Mechanical Equipment, Stair or Elevator Bulkhead □ Occupiable □ Solar □ REAR YARD ADDITION (check all that apply): □ Deck □ Occupiable			
XCAVATIONS, SIDEWALKS AND SITEV	□ IN	IFILL   LIGHTING   SIGNAC	GE ☐ AWNINGS ☐ SECURITY GATE		
	VORK SI	<ul> <li>□ EXCAVATION (check all that apply):</li> <li>□ Underpinning</li> <li>□ SIDEWALK PAVING (check all that apply):</li> <li>□ Concrete</li> <li>□ Stone</li> <li>□ Tree Pit</li> <li>□ SUBSURFACE UTILITIES (check all that apply):</li> <li>□ Residential</li> <li>□ Other</li> <li>□ STREET PAVING/STREETBED WORK</li> </ul>			
OTHER	□ NE	EMPORARY INSTALLATIONS:□ Sign □ Other EW UNENCLOSED SIDEWALK CAFÉ □ RENEW SIDEWALK CAFÉ LICENSE ENCES AND GATES □ BARRIER FREE ACCESS (ADA)  THER (Describe):			
. ADDITIONAL INFORMATION					
Are you filing to correct or legalize work don If YES, please include photos of work in vi		permit?	ning Letter/NOV#:		
Are you filing for a signoff or to amend a per If YES, please include photos of completed		☐ YES If <b>Yes</b> , Dock	et#:		
Are you applying to any of the following?	Dept. Of Buildi	ings ☐ City Planning	g ☐ Board of Standards and Appeals		



#### 4. ATTACH MATERIALS NEEDED TO COMPLETE THE APPLICATION

Required materials must be submitted to complete the application. These materials include documentation that explains the existing and proposed conditions, and clearly illustrates how the proposed work does or does not meet LPC Rules. Depending on the type of work proposed these materials may include drawings, photographs, photo-montages, material samples and written specifications.

For a complete list of materials required for the most common work types, please refer to the **Permit Application Guide** as you complete the application. LPC Rules and guides are available on the website: <a href="https://www.nyc.gov/landmarks">www.nyc.gov/landmarks</a>. An application that includes all of the required materials can often be expedited. Incomplete submissions will cause delays.

PLEASE NOTE THAT A PERMIT CANNOT BE ISSUED UNTIL THE REQUIRED MATERIALS ARE SUBMITTED AND STAFF HAS DETERMINED THAT THE APPLICATION IS COMPLETE. YOU MAY CONTACT LPC IF YOU NEED INFORMATION ABOUT THE APPLICATION PROCESS, DETAILS ABOUT THE TYPES OF DRAWINGS OR OTHER MATERIALS THAT MAY BE REQUIRED, OR FOR GENERAL GUIDANCE: TEL: (212) 669-7817/ E-MAIL: <a href="mailto:info@lpc.nyc.gov">info@lpc.nyc.gov</a>.

AN APPLICATION MAY BE COMPLETED BY THE OWNER, TENANT, LESSEE, CO-OP SHAREHOLDER, ARCHITECT, ENGINEER, CONTRACTOR, OR OTHER INDIVIDUAL OR FIRM. PLEASE LIST ALL RELEVANT CONTACTS BELOW, AND CHECK THE PRIMARY CONTACT.

5. CONTACT INFORMATION (Fill out all that apply and indicate who the	primary contact should be)	
TENANT/LESSE/CO-OP SHAREHOLDER	☐ PRIMARY CONTACT	
Name Russell Cooper	Company/Corporation/Organization S	aelidab Realty Corp. c/o Novur
Address 801 2nd Avenue, Suite 404	City & State New York, NY	<sup>Zip</sup> 10017
Phone 212-518-2693	E-mail russell@novumprop	ertiesinc.com
ARCHITECT/ENGINEER/CONTRACTOR (IF APPLICABLE)	☐ PRIMARY CONTACT	
Name Howard L. Zimmerman	Company/Corporation/Organization	loward L. Zimmerman Architec
Address 11 West 30th Street	City & State New York, NY	<sup>Zip</sup> 10001
Phone 212-564-9393	E-mail howard@hlzimmerm	an.com
PERSON FILING APPLICATION (E.G., EXPEDITOR, ATTORNEY, MANAGE	GING AGENT)   PRIMARY CONTAC	Γ
Name Arie Isaacs	Company/Corporation/Organization:	Howard L. Zimmerman Archited
Address 11 West 30th Street	City & State New York, NY	<sup>Zip</sup> 10001
Phone 212-564-9393	E-mail aisaacs@hlzimmer	man.com
6. OWNER'S INFORMATION, CONSENT, AND SIGNATURE		
I am the owner of the above-listed property. For applications for work on or ir Condominium Association. An officer of the Co-op Board or Condominium Ascarried out on my property and give my permission for this application to be f  IMPORTANT: The managing agent of a cooperative or condominium associated as a cooperative or condominium as a cooperative or c	ssociation must sign this application. I ar iled. The information entered is correct a	n familiar with the work proposed to be and complete, to the best of my knowledge.
TITLE (if applicable) President		
COMPANY, CORPORATION, OR ORGANIZATION (if applicable) Saelid		
MAILING ADDRESS 801 2nd Avenue, Suite 404	CITY, STATE, ZIP CODE New	
PHONE 212-518-2693 E-MAIL russe	ell@novumpropertiesinc.co	<u>om</u>
Agent		
SIGNATURE OF OWNER OR AUTHORIZED REPRESENTATIVE		



May 18, 2017

The New York City Landmarks Preservation Commission ONE CENTRE STREET, 9<sup>TH</sup> FLOOR New York, New York 10007

**Delivered by Hand** 

Re:

225 East 5th Street

New York, New York 10003 Reference #: 17-0039 HVAC Master Plan

To Whom It May Concern:

Howard L. Zimmerman Architects, P.C. (HLZ) has been retained by the Owners of the above building to generate a Master Plan for Apartment HVAC Upgrades throughout the building. The subject building falls under the jurisdiction of the New York City Landmarks Commission (LPC), and as such, we are providing your office with the following information and submittals for your review, comment and/or approval:

Please note, the above subject building is a rental building with many of the apartment units currently occupied. As such, the below scope of work is proposed to be performed on an individual apartment basis, as each respective apartment unit becomes vacant. This plan has been prepared to provide a holistic design that will preserve and improve the look of the existing historic façade by regularizing penetrations and making them less visible by coloring the proposed louver grilles to match the existing surrounding historic brick masonry.

South Facing Principal Facade (Front Building) (please refer to attached drawings and photo sheet).

- 1. Remove six (6) existing thru-wall gas fired furnaces (typical) and two (2) existing thru-window gas fired furnaces. Refer to detail #2 on drawing M-701.00 for existing thru-wall opening dimensions
- 2. Enlarge six (6) existing thru-wall openings for installation of new Amana model # PBH113G35CB\* thru-wall heat pump units. New thru-wall heat pumps to be provided with new Amana thru-wall sleeve (model # PBWS01A) and rimless architectural grille (model # PBAGK01SB). New architectural grille to match the color of existing surrounding brick, centered beneath existing window and is to be mounted flush with building facade. (typical for all thru-wall heat pump installations, one per apartment). Refer to details #1 and #2 on drawing M-701.00.
- 3. Install two (2) new thru-window Amana model # PBH113G35CB\* heat pump units. New heat pumps to be installed in lower section of existing window opening and is to be provided with new Amana rimless architectural grille (model # PBAGK01SB). New architectural grille to match the color of existing surrounding brick, horizontally centered within existing window frame and is to be mounted flush with building facade. Refer to detail #3 on drawing M-701.00.

North Facing Secondary Façade (Front Building) (please refer to attached drawings and photo sheet). Note, North Facing Secondary Façade of Front Building is not visible from public thoroughfare.

- 1. Remove seven (7) existing thru-wall gas fired furnaces (typical). Refer to detail #2 on drawing M-701.00 for existing thru-wall opening dimensions
- 2. Enlarge seven (7) existing thru-wall openings and create one (1) new thru-wall opening for installation of new Amana model # PBH113G35CB\* thru-wall heat pump units. New thru-wall heat pumps to be provided with new Amana thru-wall sleeve (model # PBWS01A) and



rimless architectural grille (model # PBAGK01SB). New architectural grille to match the color of existing surrounding brick, centered beneath existing window and is to be mounted flush with building facade. (typical for all thru-wall heat pump installations, one per apartment). Refer to details #1 and #2 on drawing M-701.00.

<u>South Facing Secondary Façade (Rear Building)</u> (please refer to attached drawings and photo sheet). Note, South Facing Secondary Façade of Rear Building is not visible from public thoroughfare.

- Remove five (5) existing thru-wall gas fired furnaces (typical) and one (1) existing thruwindow gas fired furnace. Refer to detail #2 on drawing M-701.00 for existing thru-wall opening dimensions
- 2. Enlarge five (5) existing thru-wall openings and create five (5) new thru-wall openings for installation of new Amana model # PBH113G35CB\* thru-wall heat pump units. New thru-wall heat pumps to be provided with new Amana thru-wall sleeve (model # PBWS01A) and rimless architectural grille (model # PBAGK01SB). New architectural grille to match the color of existing surrounding brick, centered beneath existing window and is to be mounted flush with building facade. (typical for all thru-wall heat pump installations, one per apartment). Refer to details #1 and #2 on drawing M-701.00.
- 3. Repair lower sash of one (1) existing window to match existing divided light pattern of same window.

<u>West Facing Secondary Façade (Rear Building)</u> (please refer to attached drawings). Note, West Facing Secondary Façade of Rear Building is not visible from public thoroughfare. No work proposed at West Facing Secondary Façade.

<u>East Facing Secondary Façade (Rear Building)</u> (please refer to attached drawings). Note, East Facing Secondary Façade of Rear Building is not visible from public thoroughfare. No work proposed at East Facing Secondary Façade.

North Facing Secondary Façade (Rear Building) (please refer to attached drawings). Note, North Facing Secondary Façade of Rear Building is not visible from public thoroughfare. No work proposed at North Facing Secondary Façade.

#### Notes for proposed installations:

- 1. Proposed heat pump and louver installations are to be centered beneath existing windows.
- 2. Proposed installation shall conform (and improve uniformity of) existing building facade pattern.
- 3. Proposed architectural louver to be rimless type.
- 4. Proposed architectural louver to be mounted flush with building facade.
- Proposed architectural louver to be finished to match color of existing building brick.
- 6. Proposed locations corresponds to an established regular pattern of thru-wall installations.
- 7. Proposed installation calls for one (1) heat pump per apartment.
- 8. No decorative masonry or other significant architectural features of the building shall be affected by this installation.



All materials utilized for this work will match existing for type and color as closely as possible. Should you have any questions or comments regarding this matter, please feel free to contact this office at your convenience.

Attachments: Color photographs of proposed area of work

OF NE 1004 80 M-205.00, M-206.00, M-207.00, M-208.00, M-209.00, M-501.00 & M-701.00) Drawing set (sheets T-000.00, G-101.00, M-101.00, M-201.00, M-202.00, M-203.00, M-

Jon Colatrella | PE, CEM, CBCP Executive Director, MEP/FP

**HOWARD L. ZIMMERMAN ARCHITECTS, P.C.** 





#### Photo 1:

South Facing Principal Façade (Front Building) on East 5<sup>th</sup> Street



#### Photo 2:

Alternate view of South Facing Principal Façade (Front Building) on East 5th Street.

Yellow arrows point to existing thruwall gas fired furnaces.





#### Photo 3:

North Facing Secondary Façade (Front Building); not visible from public thoroughfares.

Yellow arrows point to existing thruwall gas fired furnaces.



#### Photo 4:

Alternate view of North Facing Secondary Façade (Front Building); not visible from public thoroughfares.

Yellow arrows point to existing thruwall gas fired furnaces. Note, second floor thru-wall gas fired furnaces that are shown in Photo #3 above, are not shown in this photo as they did not fit in the photographed area.





#### Photo 5:

South Facing Secondary Façade (Rear Building); not visible from public thoroughfares.

Yellow arrows point to examples of existing thru-wall and one (1) thru-window gas fired furnaces.



#### Photo 6:

Alternate view of South Facing Secondary Façade (Rear Building); not visible from public thoroughfares.

LPC Submittal Letter Date: 5/18/2017 | Page: 6 of 6

#### LIST OF DRAWINGS:

	MECHANICAL DRAWINGS					
Sheet Number	Sheet Title					
T-000.00	COVER PAGE					
G-101,00	DOB INFORMATION, INSPECTION NOTE					
M-101.00	TYPICAL FLOOR PLANS					
M-201.00	EXISTING SOUTH (PRINCIPAL FACADE) ELEVATION					
M-202.00	EXISTING NORTH (SECONDARY FACADE) ELEVATION					
M-203.00	EXISTING REAR BUILDING SOUTH (SECONDARY FACADE) ELEVATION					
M-204.00	EXISTING REAR BUILDING WEST (SECONDARY FACADE) ELEVATION					
M-205.00	EXISTING REAR BUILDING EAST (SECONDARY FACADE) ELEVATION					
M-206.00	EXISTING REAR BUILDING NORTH (SECONDARY FACADE) ELEVATION					
M-207,00	PROPOSED SOUTH (PRINCIPAL FACADE) ELEVATION					
M-208.00	PROPOSED NORTH (SECONDARY FACADE) ELEVATION					
M-209.00	PROPOSED REAR BUILDING SOUTH (SECONDARY FACADE) ELEVATION					
M-501.00	EQUIPMENT SCHEDULES					
M-701.00	DETAILS					

# HVAC MASTER PLAN

## 225 EAST 5TH STREET NEW YORK, NY 10003

#### OBJECTIVE:

THIS MASTER PLAN SHALL ESTABLISH A PROGRAM FOR UPGRADES TO APARTMENT HVAC INSTALLATIONS. INSTALLATIONS SHALL BE REGULARIZED, LESS VISIBLE, AND PRESERVE AND IMPROVE AN EXISTING PATTERN OF THRU-WALL HVAC INSTALLATIONS THAT WILL BE LESS DISRUPTIVE THE BUILDING'S EXISTING HISTORIC FACADE.


# HVAC MASTER PLAN COVER PAGE NOVEM PROPERTIES, INC.

# PROJECT LOCATIONS of I Relia Federa Credit Un

#### PROJECT INFORMATION

**NOVEM PROPERTIES, INC.** 

801 2ND AVENUE, SUITE 404 NEW YORK, NY 10017

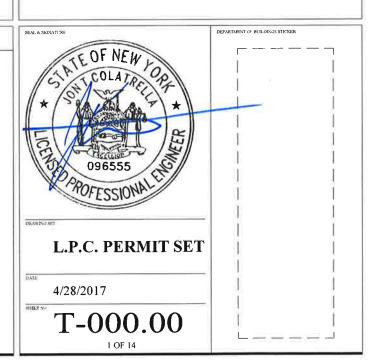

#### **DEMOLITION NOTES**

- ALL EXISTING STRUCTURES ARE SHOWN FOR REFERENCE ONLY AND ARE TO BE FIELD VERIFIED.
- REMOVED MATERIALS, UNLESS OTHERWISE NOTED, BECOME THE PROPERTY OF THE CONTRACTOR AND SHALL BE REMOVED FROM THE SITE IN ACCORDANCE WITH ALL APPLICABLE LAWS, CODES AND REGULATIONS.
- CONTRACTOR SHALL USE QUALIFIED, EXPERIENCED PERSONNEL FOR REMOVAL AND DEMOLITION OPERATIONS. REMOVAL AND DEMOLITION OPERATIONS SHALL BE PERFORMED IN A CAREFUL, ORDERLY AND CONTROLLED MANNER TO AVOID HAZARDS TO PERSONS, DAMAGE TO PROPERTY, AND SPREADING OF DUST AND DEBRIS.
- EXACT EXTENT OF DEMOLITION TO BE DONE SHALL BE VERIFIED AT THE SITE, DETERMINE THE NATURE AND EXTENT OF DEMOLITION THAT WILL BE NECESSARY BY COMPARING THE DRAWINGS WITH THE EXISTING CONSTRUCTION.
- THE CONTRACTOR IS FULLY RESPONSIBLE FOR THE MEANS AND METHODS OF DEMOLITION AND SHORING AND THE SAFETY OF THE EXISTING STRUCTURE AND ITS OCCUPANTS.
- THE CONTRACTOR IS NOT TO REMOVE ANY MORE OF THE EXISTING STRUCTURE THAN NECESSARY TO PROPERLY EXECUTE THE DETAILS SHOWN ON CONTRACT DOCUMENT. DO NOT DAMAGE, MAR, OR DEFACE THE REMAINING STRUCTURE OR MATERIALS TO BE REUSED.
- CONTRACTOR SHALL PRESERVE AND PROTECT ALL EXISTING UTILITIES, DUCTS, AND EQUIPMENT TO REMAIN.
- CONTRACTOR IS RESPONSIBLE FOR THE DESIGN, INSTALLATION AND MONITORING OF ALL TEMPORARY FACILITIES AND STRUCTURES.
- ENERGY CODE COMPLIANCE INSPECTIONS BC 110.3.5

#### 2016 NEW YORK ENERGY CODE COMPLIANCE

TO THE BEST OF MY KNOWLEDGE, BELIEF AND PROFESSIONAL JUDGMENT, THESE PLANS AND SPECIFICATIONS ARE IN COMPLIANCE WITH THE ENERGY CONSERVATION CODE OF NEW YORK CITY (NYCECC 2016).

#### FLOOD ZONE STATEMENT:

THE APPLICANT HAS BEEN ADVISED THAT THE PROPERTY IS NOT LOCATED IN SPECIAL FLOOD HAZARD AREA (SFHA). ZONE AS PER PRELIMINARY FLOOD MAPS RELEASED IN 2013

#### TENANT PROTECTION PLAN (PER 28-104.8.4)

- EGRESS. AT ALL TIMES IN THE COURSE OF CONSTRUCTION PROVISION SHALL BE MADE FOR ADEQUATE EGRESS AS REQUIRED BY THIS CODE AND THE TENANT PROTECTION PLAN SHALL IDENTIFY THE EGRESS THAT WILL BE PROVIDED, REQUIRED EGRESS SHALL NOT BE OBSTRUCTED AT ANY TIME EXCEPT WHERE APPROVED BY THE COMMISSIONER.
- FIRE SAFETY, ALL NECESSARY LAWS AND CONTROLS, INCLUDING THOSE WITH RESPECT TO OCCUPIED DWELLINGS, AS WELL AS ADDITIONAL SAFETY MEASURES NECESSITATED BY THE CONSTRUCTION SHALL BE STRICTLY OBSERVED.
- HEALTH REQUIREMENTS. SPECIFICATION OF METHODS TO BE USED FOR CONTROL OF DUST, DISPOSAL OF CONSTRUCTION DEBRIS, PEST CONTROL AND MAINTENANCE OF SANITARY FACILITIES, AND LIMITATION OF NOISE TO ACCEPTABLE LEVELS SHALL BE INCLUDED. NOTE: THERE SHALL BE INCLUDED A STATEMENT OF COMPLIANCE WITH APPLICABLE PROVISIONS OF LAW RELATING TO LEAD AND ASBESTOS.
- COMPLIANCE WITH HOUSING STANDARDS. THE REQUIREMENTS OF THE NEW YORK CITY HOUSING MAINTENANCE CODE, AND, WHERE APPLICABLE, THE NEW YORK STATE MULTIPLE DWELLING LAW SHALL BE STRICTLY OBSERVED.
- STRUCTURAL SAFETY. NO STRUCTURAL WORK SHALL BE DONE THAT MAY ENDANGER THE OCCUPANTS.
- NOISE RESTRICTIONS. WHERE HOURS OF THE DAY OR THE DAYS OF THE WEEK IN WHICH CONSTRUCTION WORK MAY BE UNDERTAKEN ARE LIMITED PURSUANT TO THE NEW YORK CITY NOISE CONTROL CODE, SUCH LIMITATIONS SHALL BE STATED.
- CONSTRUCTION OPERATIONS WILL BE CONFINED TO NORMAL WORKING HOURS OF 8 AM TO 5 PM MONDAY THROUGH FRIDAY EXCEPT HOLIDAYS WHICH WILL BE DETERMINED BY THE OWNER. NO WORK WILL BE DONE ON WEEKENDS WITHOUT WRITTEN PERMISSION BY THE OWNER OR WITHOUT A PERMIT.
- ALL UNITS ARE TO BE OCCUPIED DURING CONSTRUCTION

#### SPECIAL INSPECTIONS

SPECIAL INSPECTIONS REQUIRED IN ACCORDANCE WITH SECTION BC 1704 AND THE APPLICABLE SECTIONS OF THE BUILDING CODE SHALL BE PERFORMED FOR THE FOLLOWING ITEMS:

SPECIAL INSPECTIONS	CODE / SECTION
FINAL INSPECTION	28-116.2.4.2, BC 110.5, DIRECTIVE 14/75, 1 RCNY 101-10

#### DEPARTMENT OF BUILDINGS INFORMATION

OWNER:

PROJECT ADDRESS:

SAELIDAB REALTY CORP. c/o NOVUM PROPERTIES, INC. 6 EAST 39TH STREET, SUITE 701 NEW YORK, NY 10016

225 EAST 5TH STREET NEW YORK, NY 10003

ZONE:

R8B

# OF STORIES:

MAP: BOROUGH:

USE:

12C

BIN NUMBER:

HEIGHT:

LOT:

55' - 0" 1076948

LANDMARK STATUS: YES

BLOCK: 44


461

CONSTRUCTION:


RESIDENTIAL 3-NON FP STRUC

**MANHATTAN** 

EXTERIOR SYMBOLS LEGEND

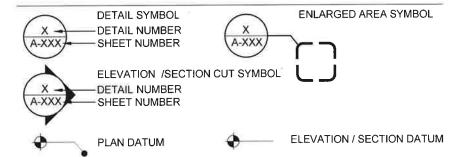



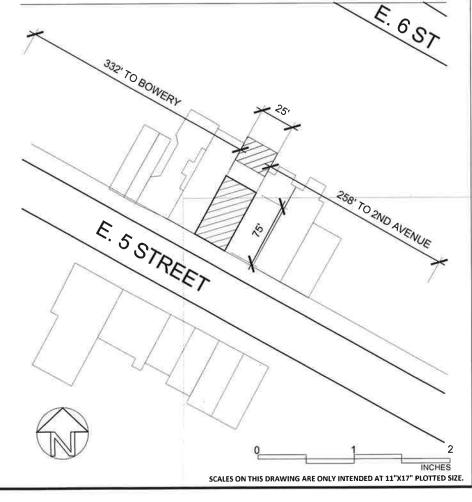

#### HVAC MASTER PLAN

225 EAST 5TH STREET NEW YORK, NY 10003

NOVEM PROPERTIES, INC. 801 2ND AVENUE, SUITE 404 NEW YORK, NY 10017





DOB INFORMATION. INSPECTION NOTES

4/28/2017 AS NOTED JOB N 17-0039 2 of 14

G-101.00

#### NOTES:

- 1. PROPOSED HEAT PUMP AND LOUVER INSTALLATIONS ARE TO BE CENTERED BENEATH EXISTING WINDOWS.
- 2. PROPOSED INSTALLATION SHALL CONFORM (AND IMPROVE UNIFORMITY OF) EXISTING BUILDING FACADE PATTERN.
- 3. PROPOSED ARCHITECTURAL LOUVER/GRILLE TO BE RIMLESS TYPE.
- 4. PROPOSED ARCHITECTURAL LOUVER/GRILLE TO BE MOUNTED FLUSH WITH BUILDING FACADE.
- PROPOSED ARCHITECTURAL LOUVER/GRILLE TO BE FINISHED TO MATCH COLOR OF EXISTING BUILDING BRICK.
- PROPOSED LOCATIONS CORRESPOND TO AN EXISTING ESTABLISHED REGULAR PATTERN OF THRU-WALL INSTALLATIONS.
- 7. PROPOSED INSTALLATION CALLS FOR ONE (1) HEAT PUMP PER APARTMENT.
- NO DECORATIVE MASONRY AND/OR OTHER SIGNIFICANT ARCHITECTURAL FEATURES OF THE BUILDING SHALL BE AFFECTED BY THIS INSTALLATION.

INSTALL NEW AMANA MODEL # PBH113G35CB\*
THRU-WALL HEAT PUMP UNIT. NEW THRU-WALL
HEAT PUMP TO BE PROVIDED WITH NEW AMANA
THRU-WALL SLEEVE (MODEL # PBWS01A) AND
RIMLESS ARCHITECTURAL GRILLE (MODEL #
PBAGK01SB). NEW ARCHITECTURAL GRILLE TO
MATCH COLOR OF EXISTING SURROUNDING
BRICK, CENTERED BENEATH EXISTING WINDOW
AND IS TO BE MOUNTED FLUSH WITH BUILDING
FACADE. (TYPICAL FOR ALL THRU-WALL HEAT
PUMP INSTALLATIONS, ONE PER APARTMENT).
REFER TO DETAIL #1 ON DRAWING M-701,00.
PROPOSED LOCATION OF NEW THRU-WALL HEAT
PUMP UNIT

(TYPICAL FOR ALL BUBBLED LOCATIONS)

HVAC MASTER PLAN

225 EAST 5TH STREET NEW YORK, NY 10003

NOVEM PROPERTIES, INC.

801 2ND AVENUE, SUITE 404 NEW YORK, NY 10017



11 West 30th Street, New York, NY 10001 Phone, 212,564,9393 ; Fax, 212,564,9032



NO DATE REVISION DESCRIPTION


TYPICAL FLOOR PLANS

DATE 4/28/2017 DRAWN BY

SCALE: AS NOTED

OBINO 17-0039 PAGE: 3 of 14

M-101.00

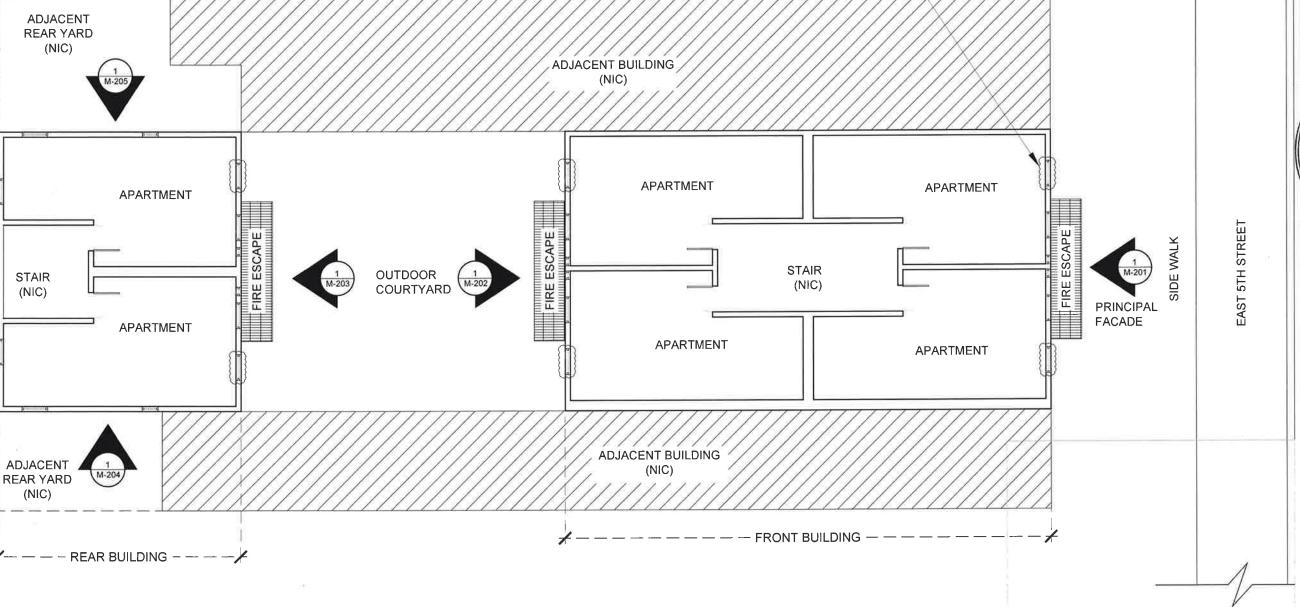



TYPICAL FLOOR PLANS
DIAGRAMATIC

0 1 INCH

SCALES ON THIS DRAWING ARE ONLY INTENDED AT 11"X17" PLOTTED SIZE.

REMOVE SIX (6)
EXISTING
THRU-WALL GAS
FIRED FURNACES
(TYPICAL) REFER
TO DETAIL #2 ON
DRAWING M-701.00
FOR EXISTING
THRU-WALL
OPENING
DIMENSIONS



ADJACENT BUILDING (FRONT) (NIC)





**HVAC MASTER PLAN** 

225 EAST 5TH STREET NEW YORK, NY 10003

NOVEM PROPERTIES, INC.

801 2ND AVENUE, SUITE 404 NEW YORK, NY 10017



NO DATE REVISION DESCRIPTION

EXISTING SOUTH (PRINCIPAL FACADE) ELEVATION

ATE: 4/28/2017 DRAWN BY: 4/28/2017 CHECKED BY: AS NOTED PAGE:

M-201.00

REMOVE TWO (2) EXISTING GAS FIRED FURNACE CURRENTLY INSTALLED IN LOWER PORTION OF EXISTING WINDOW OPENING. EXISTING WINDOW FRAME AND ASSEMBLY TO REMAIN.

REMOVE SEVEN (7) EXISTING THRU-WALL GAS FIRED FURNACES (TYPICAL) REFER TO DETAIL #2 ON DRAWING M-701.00 FOR EXISTING THRU-WALL **OPENING** DIMENSIONS ADJACENT ADJACENT BUILDING BUILDING (NIC) (NIC) COMMERCIAL COMMERCIAL SPACE #2 SPACE #1 (NOT IN (NOT IN SCOPE) SCOPE)

EXISTING NORTH (SECONDARY FACADE) ELEVATION

DIAGRAMATIC

HVAC MASTER PLAN


225 EAST 5TH STREET NEW YORK, NY 10003

NOVEM PROPERTIES, INC.

801 2ND AVENUE, SUITE 404 NEW YORK, NY 10017



11 West 30th Street, New York, NY 10001 Phone, 212,564,9393 i Fax, 212,564,9032

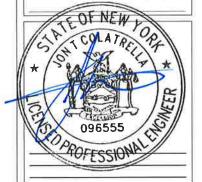

NO DATE REVISION DESCRIPTION

EXISTING NORTH (SECONDARY FACADE) ELEVATION

DATE: 4/28/2017 DRAWN BY:

SCALE: AS NOTED

JOB No. 17 0020 PAGE: 5 or 1/4

M-202.00


NOTE:

NORTH FACADE IS NOT VISIBLE FROM PUBLIC THOROUGHFARES.

O 1 2
INCHES

SCALES ON THIS DRAWING ARE ONLY INTENDED AT 11"X17" PLOTTED SIZE.

REMOVE FIVE (5)
EXISTING
THRU-WALL GAS
FIRED FURNACE
(TYPICAL ) REFER TO
DETAIL #2 ON
DRAWING M-701.00
FOR EXISTING
THRU-WALL
OPENING
DIMENSIONS

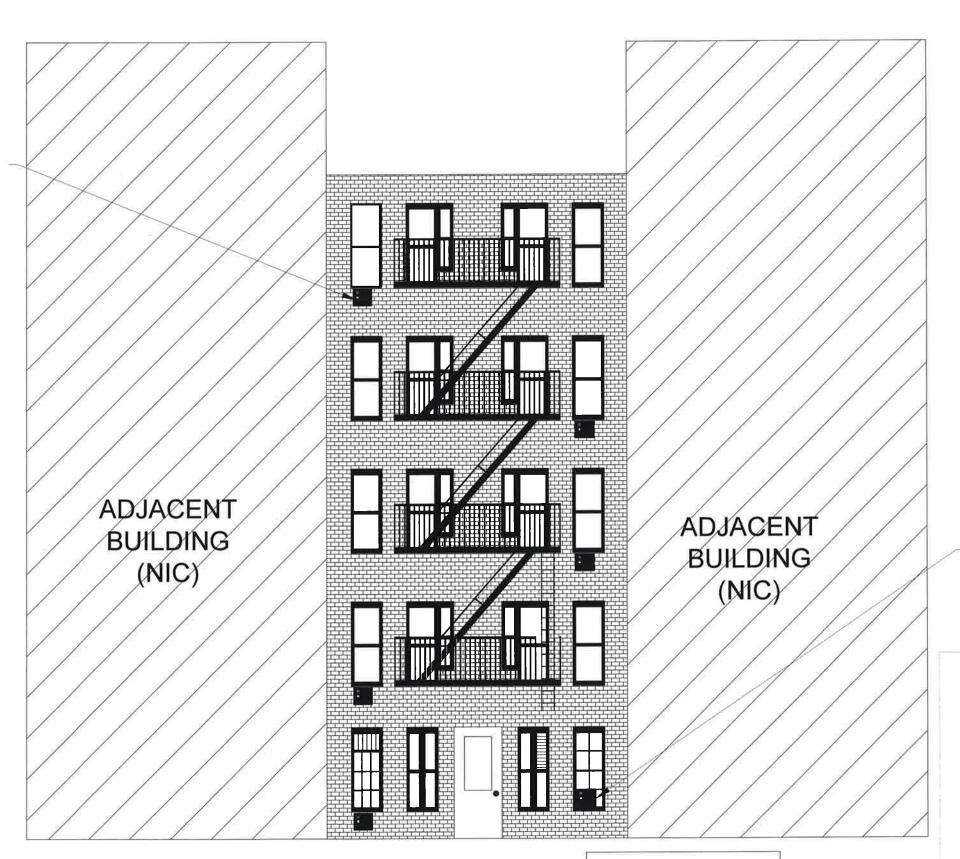

REMOVE ONE (1) EXISTING
GAS FIRED FURNACE
CURRENTLY INSTALLED IN
LOWER LEFT SASH OF
EXISTING WINDOW. EXISTING
WINDOW TO BE REPAIRED TO
MATCH EXISTING WINDOW
DIVIDED LIGHT PATTERN.

HVAC MASTER PLAN

225 EAST 5TH STREET NEW YORK, NY 10003

NOVEM PROPERTIES, INC.

801 2ND AVENUE, SUITE 404 NEW YORK, NY 10017



11 West 30th Street, New York, NY 10001 Phone, 212 564 9393 | Fax: 212 564 9032



NO DATE REVISION DESCRIPTION

EXISTING REAR BUILDING SOUTH (SECONDARY FACADE) ELEVATION

4/28/2017 DRAWN HY

ALE:
AS NOTED

AS NOTED

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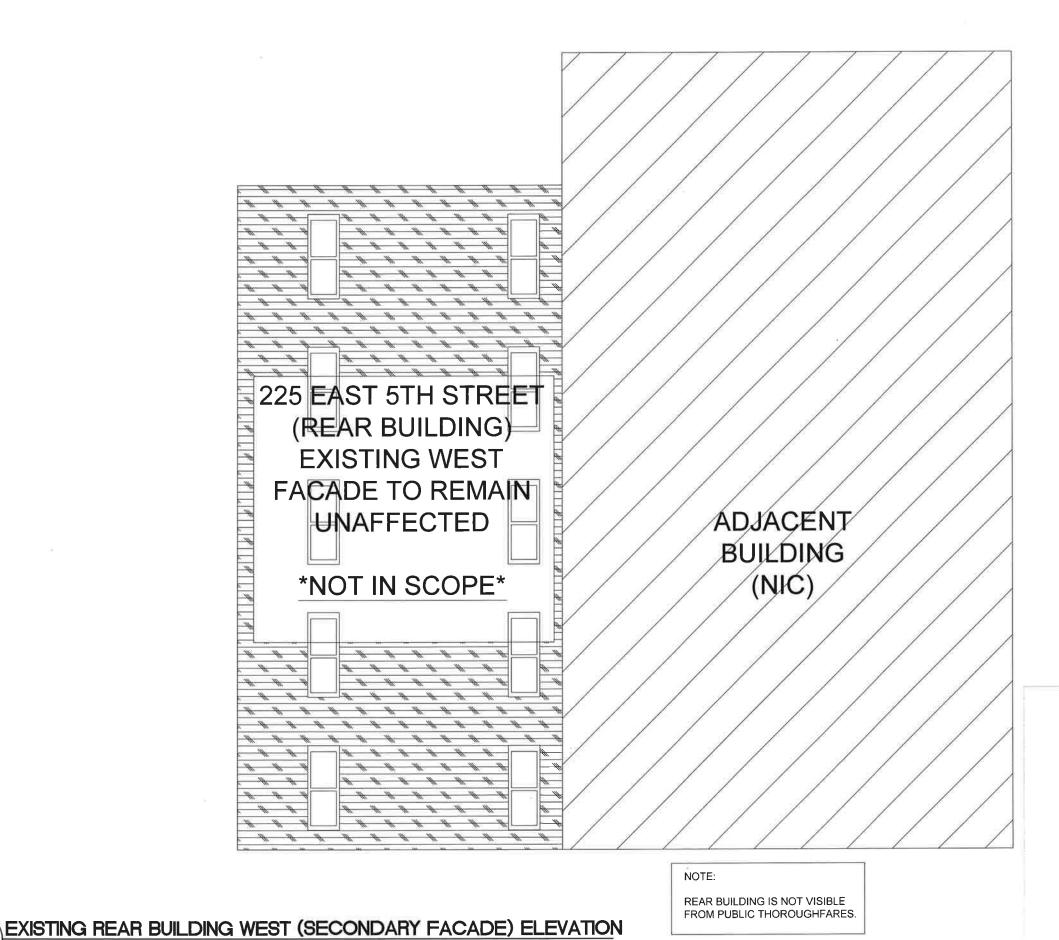
M-203.00

EXISTING REAR BUILDING SOUTH (SECONDARY FACADE) ELEVATION
DIAGRAMATIC

NOTE:

REAR BUILDING IS NOT VISIBLE FROM PUBLIC THOROUGHFARES.





DIAGRAMATIC

**HVAC MASTER PLAN** 

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NO DATE REVISION DESCRIPTION

EXISTING REAR BUILDING WEST (SECONDARY FACADE) ELEVATION

DATE: 4/28/2017 DRAWN BY.

SCALE AS NOTED


JOB No. 17-0039 PAGE: 7 of 14

M-204.00

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INCHES

SCALES ON THIS DRAWING ARE ONLY INTENDED AT 11"X17" PLOTTED SIZE.

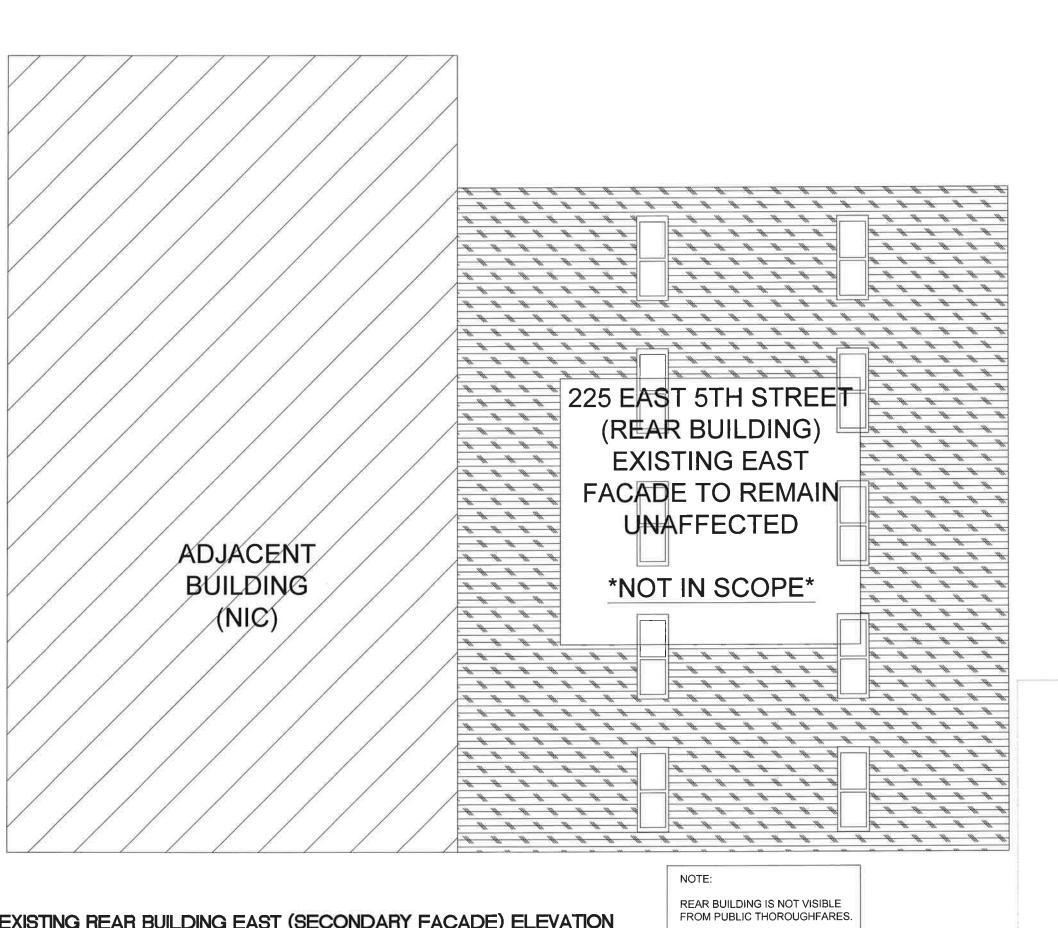

**HVAC MASTER PLAN** 


225 EAST 5TH STREET NEW YORK, NY 10003

NOVEM PROPERTIES, INC.

801 2ND AVENUE, SUITE 404 NEW YORK, NY 10017




11 West 30th Street, New York, NY 1000

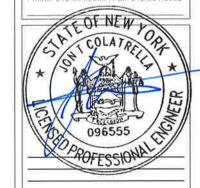

NO. DATE REVISION DESCRIPT

EXISTING REAR BUILDING EAST (SECONDARY FACADE) ELEVATION

M-205.00

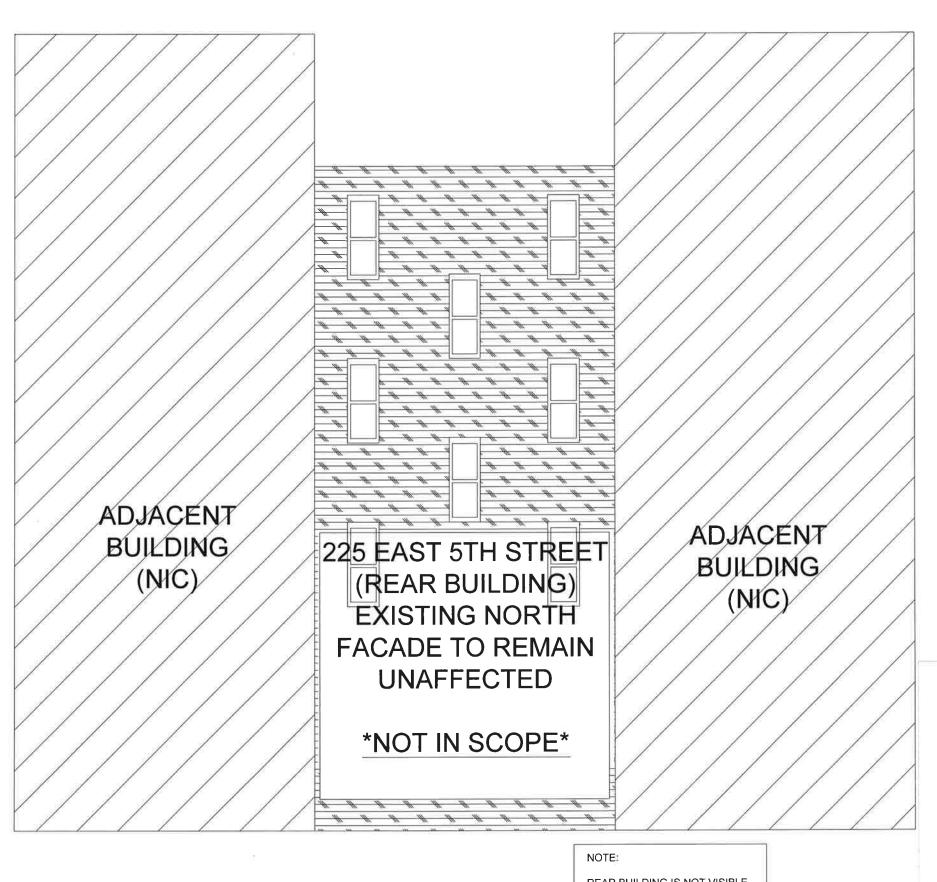

EXISTING REAR BUILDING NORTH (SECONDARY FACADE) ELEVATION

DIAGRAMATIC

**HVAC MASTER PLAN** 

225 EAST 5TH STREET NEW YORK, NY 10003

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801 2ND AVENUE, SUITE 404 NEW YORK, NY 10017



11 West 30th Street, New York, NY 10001



NO. DATE REVISION DESCRIPTION

EXISTING REAR BUILDING NORTH (SECONDARY FACADE) ELEVATION

M-206.00

REAR BUILDING IS NOT VISIBLE FROM PUBLIC THOROUGHFARES.

0 1 INCHES
ON THIS DRAWING ARE ONLY INTENDED AT 11"X17" PLOTTED S



- 1. NO NEW PENETRATIONS AT PRINCIPAL FACADE PROPOSED. ONLY ENLARGEMENT OF EXISTING THRU-WALL OPENINGS.
- NO SIGNIFICANT ARCHITECTURAL FEATURES WILL BE AFFECTED BY THE INSTALLATION.
- THE INSTALLATION WILL PRESERVE AND IMPROVE THE LOOK OF THE HISTORIC FACADE BY REGULARIZING PENETRATIONS AND MAKING THEM LESS VISIBLE BY COLORING THE PROPOSED LOUVER GRILLES TO MATCH THE EXISTING SURROUNDING HISTORIC BRICK MASONRY.

COMMERCIAL

SPACE #2

ENTRANCE

(NOT IN SCOPE)

**ENLARGE SIX (6) EXISTING** THRU-WALL OPENINGS FOR INSTALLATION OF NEW AMANA MODEL # PBH113G35CB\* THRU-WALL HEAT PUMP UNIT. NEW THRU-WALL HEAT PUMP TO BE PROVIDED WITH NEW AMANA THRU-WALL SLEEVE (MODEL# PBWS01A) AND RIMLESS ARCHITECTURAL GRILLE (MODEL # PBAGK01SB). NEW ARCHITECTURAL GRILLE TO MATCH COLOR OF EXISTING SURROUNDING BRICK, CENTERED BENEATH EXISTING WINDOW AND IS TO BE MOUNTED FLUSH WITH BUILDING FACADE. (TYPICAL FOR ALL THRU-WALL HEAT PUMP INSTALLATIONS, ONE PER APARTMENT), REFER TO DETAILS #1 AND #2 ON DRAWING M-701,00.

ADJACENT BUILDING

COMMERCIAL

SPACE #1 ENTRANCE

(NOT IN SCOPE)

(NIC)

ADJACENT BUILDING (FRONT) (NIĆ

NEW AMANA MODEL # PBH113G35CB\* HEAT PUMP UNIT. NEW HEAT PUMP TO BE INSTALLED IN LOWER SECTION OF EXISTING WINDOW OPENING AND IS TO BE PROVIDED WITH NEW AMANA RIMLESS ARCHITECTURAL GRILLE (MODEL # PBAGK01SB). NEW ARCHITECTURAL GRILLE TO MATCH COLOR OF EXISTING SURROUNDING BRICK, HORIZONTALLY CENTERED WITHIN EXISTING WINDOW OPENING AND IS TO BE MOUNTED FLUSH WITH BUILDING FACADE, REFER TO DETAIL #3 ON DRAWING M-701.00.

#### HVAC MASTER PLAN

225 EAST 5TH STREET NEW YORK, NY 10003

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801 2ND AVENUE, SUITE 404 NEW YORK, NY 10017



Phone 212 564 9393 | Fax 212 564 9032



NO DATE REVISION DESCRIPTION

PROPOSED SOUTH (PRINCIPAL FACADE)

ELEVATION DATE: 4/28/2017


AS NOTED

M-207.00

PROPOSED SOUTH (PRINCIPAL FACADE) ELEVATION

DIAGRAMATIC



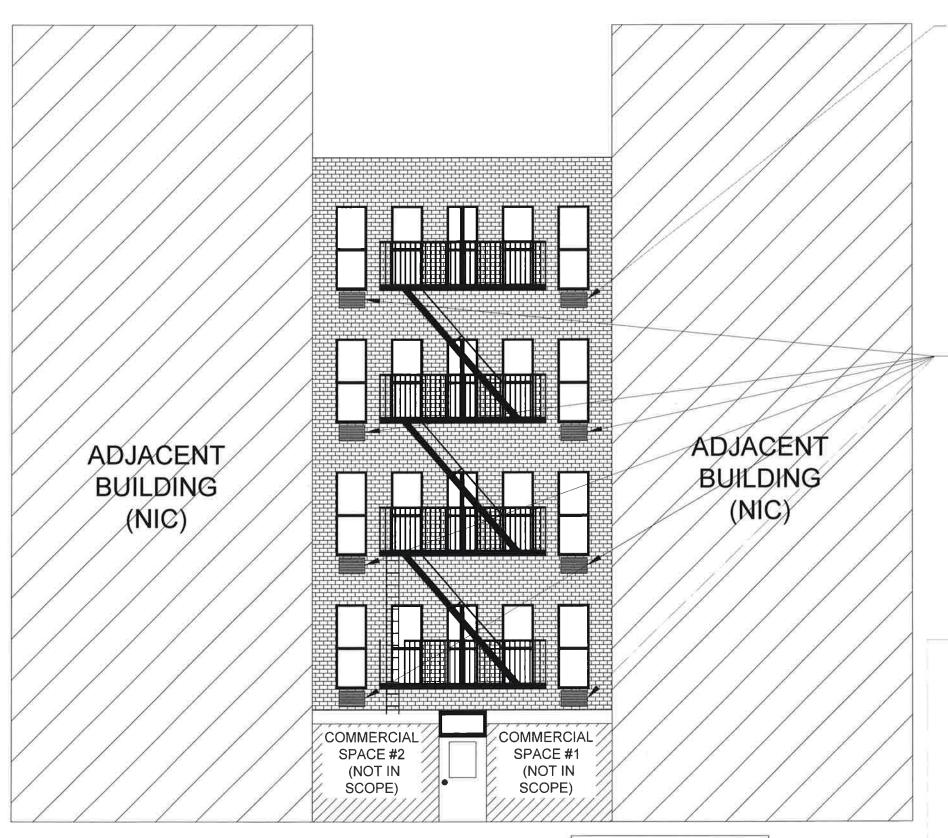

PROPOSED NORTH (SECONDARY FACADE) ELEVATION

DIAGRAMATIC

ONE (1) NEW THRU-WALL PENETRATION FOR INSTALLATION OF NEW AMANA MODEL # PBH113G35CB\* THRU-WALL HEAT PUMP UNIT. NEW THRU-WALL HEAT PUMP TO BE PROVIDED WITH NEW AMANA THRU-WALL SLEEVE (MODEL # PBWS01A) AND RIMLESS ARCHITECTURAL GRILLE (MODEL # PBAGK01SB). NEW ARCHITECTURAL GRILLE TO MATCH COLOR OF EXISTING SURROUNDING BRICK, CENTERED BENEATH EXISTING WINDOW AND IS TO BE MOUNTED FLUSH WITH BUILDING FACADE. (TYPICAL FOR ALL THRU-WALL HEAT PUMP INSTALLATIONS, ONE PER APARTMENT), REFER TO DETAILS #1 AND #2 ON DRAWING M-701.00.

ENLARGE SEVEN (7) EXISTING THRU-WALL OPENING FOR INSTALLATION OF NEW AMANA MODEL # PBH113G35CB\* THRU-WALL HEAT PUMP UNIT. NEW THRU-WALL HEAT PUMP TO BE PROVIDED WITH NEW AMANA THRU-WALL SLEEVE (MODEL # PBWS01A) AND RIMLESS ARCHITECTURAL GRILLE (MODEL # PBAGK01SB). NEW ARCHITECTURAL GRILLE TO MATCH COLOR OF EXISTING SURROUNDING BRICK, CENTERED BENEATH EXISTING WINDOW AND IS TO BE MOUNTED FLUSH WITH BUILDING FACADE. (TYPICAL FOR ALL THRU-WALL HEAT PUMP INSTALLATIONS, ONE PER APARTMENT), REFER TO DETAILS #1 AND #2 ON DRAWING M-701.00.

#### HVAC MASTER PLAN


225 EAST 5TH STREET NEW YORK, NY 10003

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801 2ND AVENUE, SUITE 404 NEW YORK, NY 10017



11 West 30th Street, New York, NY 10001 Phone: 212 564 9393 | Fax: 212 564 9032

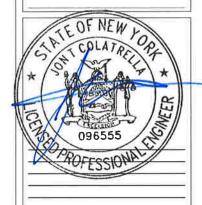

NO DATE REVISION DESCRIPTION

PROPOSED NORTH (SECONDARY FACADE) ELEVATION

DATE: 4/28/2017 DRAWN BY:
SCALE: CHECKED BY
AS NOTED

M-208.00

NŌTE:

NORTH FACADE IS NOT VISIBLE FROM PUBLIC THOROUGHFARES.

0 1 2

INCHES

SCALES ON THIS DRAWING ARE ONLY INTENDED AT 11"X17" PLOTTED SIZE.



FIVE (5) NEW THRU-WALL PENETRATIONS FOR INSTALLATION OF NEW AMANA MODEL # PBH113G35CB\* THRU-WALL HEAT PUMP UNIT. NEW THRU-WALL HEAT PUMP TO BE PROVIDED WITH NEW AMANA THRU-WALL SLEEVE (MODEL # PBWS01A) AND RIMLESS ARCHITECTURAL GRILLE (MODEL # PBAGK01SB). NEW ARCHITECTURAL GRILLE TO MATCH COLOR OF EXISTING SURROUNDING BRICK, CENTERED BENEATH EXISTING WINDOW AND IS TO BE MOUNTED FLUSH WITH BUILDING FACADE. (TYPICAL FOR ALL THRU-WALL HEAT PUMP INSTALLATIONS, ONE PER APARTMENT). REFER TO DETAILS #1 AND #2 ON DRAWING M-701,00.


HVAC MASTER PLAN
225 EAST 5TH STREET
NEW YORK, NY 10003

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801 2ND AVENUE, SUITE 404 NEW YORK, NY 10017



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NO DATE REVISION DESCRIPTION

PROPOSED REAR BUILDING SOUTH (SECONDARY FACADE) ELEVATION

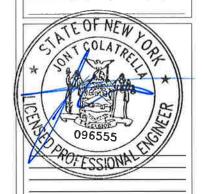M-209.00

NOTE:

REAR BUILDING IS NOT VISIBLE FROM PUBLIC THOROUGHFARES.

PROPOSED REAR BUILDING SOUTH (SECONDARY FACADE) ELEVATION
DIAGRAMATIC

**ENLARGE FIVE (5) EXISTING** 

THRU-WALL OPENINGS FOR

PBH113G35CB\* THRU-WALL

THRU-WALL HEAT PUMP TO BE PROVIDED WITH NEW AMANA THRU-WALL SLEEVE (MODEL #

INSTALLATION OF NEW

HEAT PUMP UNIT. NEW

PBWS01A) AND RIMLESS ARCHITECTURAL GRILLE (MODEL # PBAGK01SB). NEW ARCHITECTURAL GRILLE TO MATCH COLOR

SURROUNDING BRICK, CENTERED BENEATH EXISTING WINDOW AND IS TO BE MOUNTED FLUSH WITH BUILDING FACADE. (TYPICAL FOR ALL THRU-WALL HEAT PUMP INSTALLATIONS, ONE PER APARTMENT). REFER TO DETAILS #1 AND #2 ON DRAWING M-701.00.

AMANA MODEL#

OF EXISTING

0 1 2

INCHES

SCALES ON THIS DRAWING ARE ONLY INTENDED AT 11"X17" PLOTTED SIZE.

NEW HEAT PUMP UNIT SCHEDULE										
DESIGNATION	RATING (TONS)	REFRIG TYPE	COOLING CAPACITY (BTU'S)	HEATING CAPACITY (BTU'S)	POWER SUPPLY  VOLTAGE PHASE BREAKER SIZE		MAKE	MODEL	SEER (BTU/H/W)	
HPU	1	R410A	11,700	37,000	250	1	20	AMANA	PBH113G35CB*	9.5

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### EQUIPMENT SCHEDULES

DATE: 4/28/2017 DRAWN BY:
SCALE AS NOTED

JOB No. 17-0039 PAGE: 13 of 14

TOB No. 17-0039 PAGE: 13 OF 14

SHEET NO: 13 OF 14

