# APPLICATION TO THE NEW YORK CITY LANDMARKS PRESERVATION COMMISSION FOR THE TWO STORY ADDITION OF A SINGLE FAMILY RESIDENCE 16 LEROY ST, NEW YORK, NY 10014

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ADDRESS: 16 LEROY ST

LOT: 15 BLOCK: 586 ZONE: R6

ZONING MAP NUMBER: 12A HEIGHT: CELLAR + 4 STORIES

**CONSTRUCTION CLASS: 3 NON FIREPROOF** 

NOT TO SCALE FEB 5, 2020

PROJECT:


RESIDENCE 16 LEROY ST. NEW YORK, NY

TITLE SHEET

-

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LPC-000.00

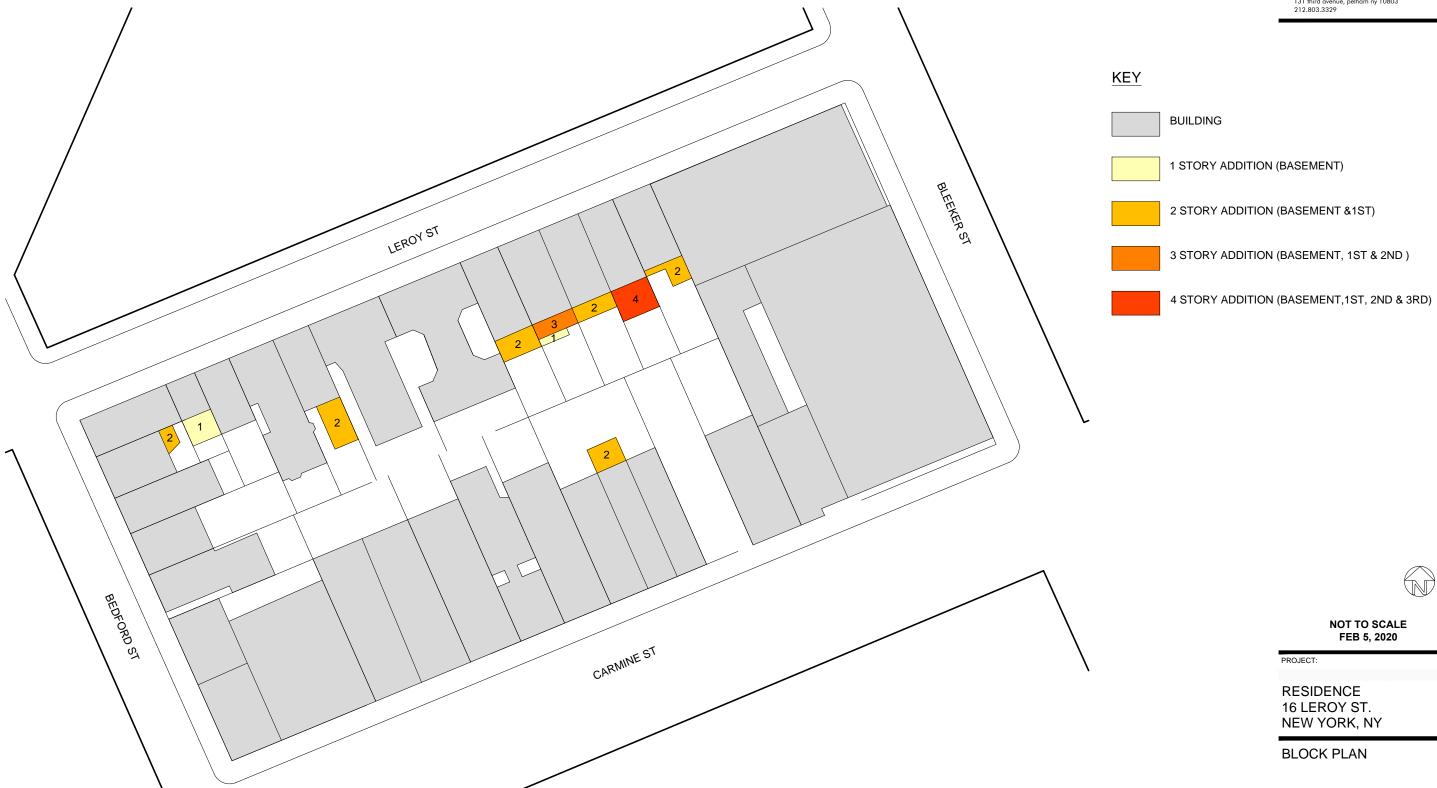

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LPC-001.00

1 BLOCK PLAN

131 third avenue, pelham ny 10803 212.803.3329




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(1) EXISTING SOUTH PHOTO FROM CARMINE ST Scale NTS







PROJECT:

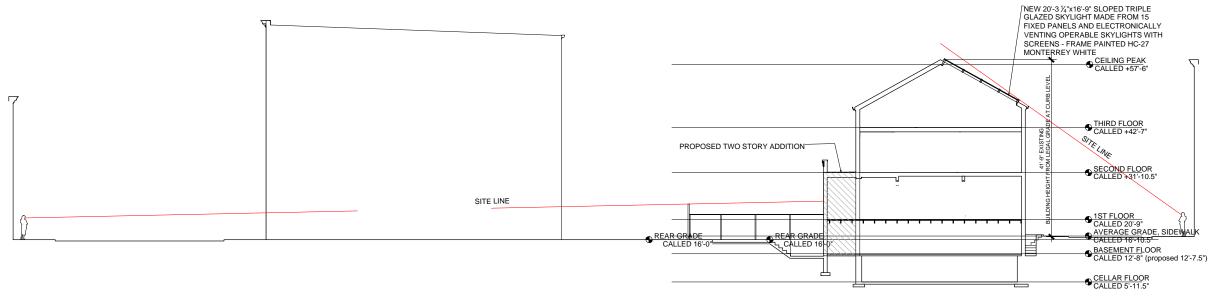RESIDENCE 16 LEROY ST. NEW YORK, NY

**PHOTOS** 

SEAL & SIGNATURE:

**EXISTING EXTERIOR** 

VIEW SITE LINES

& SITE SECTION W/ PUBLIC

SITE SECTION WITH PUBLIC VIEW SITELINES

LPC-100.00

DATE: 4/25/2019 SCALE: AS SHOWN

PROJ. NO:

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EXISTING NORTH FACADE BULDING PHOTO FROM BLEEKER STREET END

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PROJECT:


RESIDENCE 16 LEROY ST. NEW YORK, NY

EXISTING EXTERIOR PHOTOS 2 FROM PUBLIC VIEW STREET CORNERS

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LPC-101.00



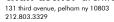

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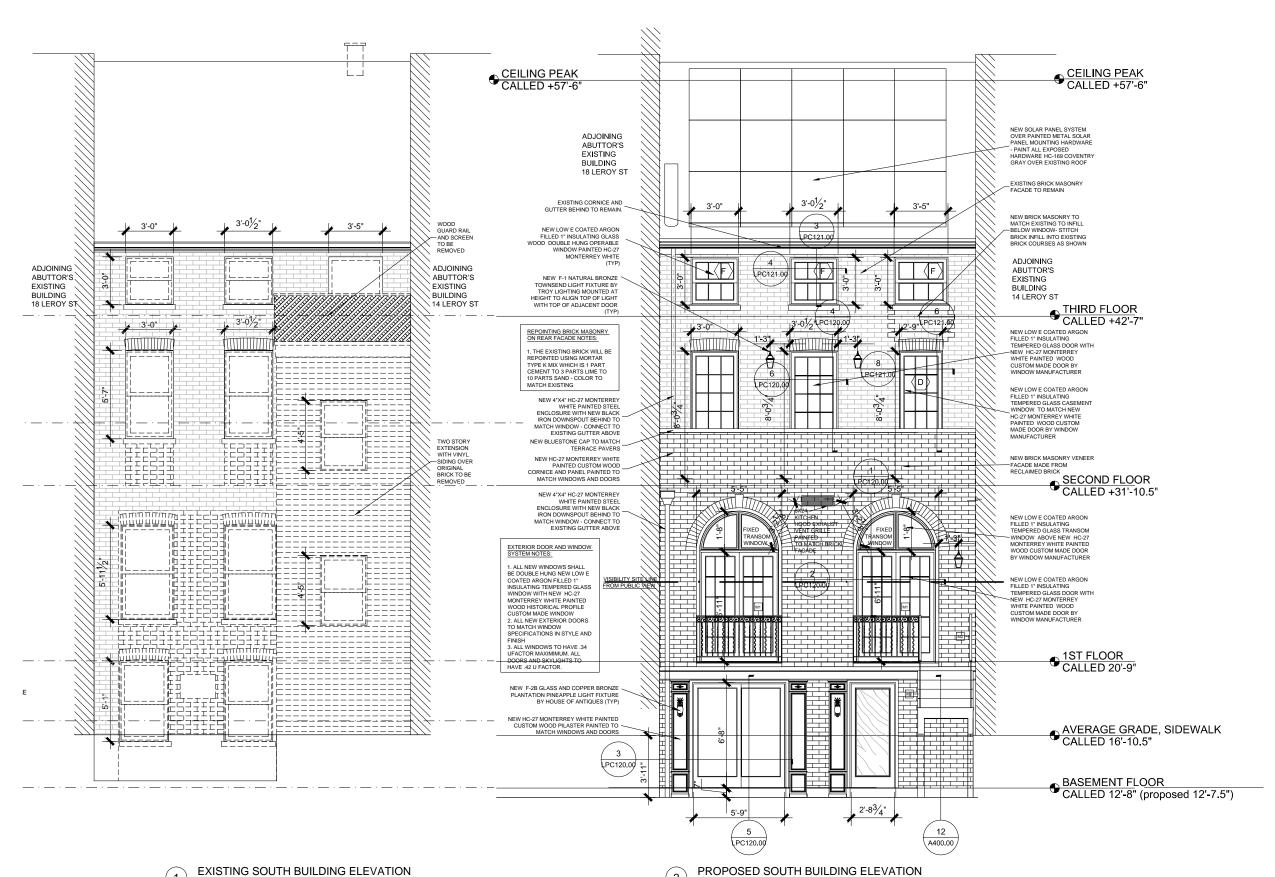
PROJECT:

RESIDENCE 16 LEROY ST. NEW YORK, NY

**EXISTING EXTERIOR ELEVATIONS** 

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LPC-110.00



NOT TO SCALE FEB 5, 2020


PROJECT:

RESIDENCE 16 LEROY ST. NEW YORK, NY


PROPOSED AND EXISTING **REAR ELEVATIONS** 

SEAL & SIGNATURE: DATE: 4/25/2019 SCALE: 1/4"=1'-0" PROJ. NO: DRAWN BY: CHK BY: DWG NO:

LPC-111.00

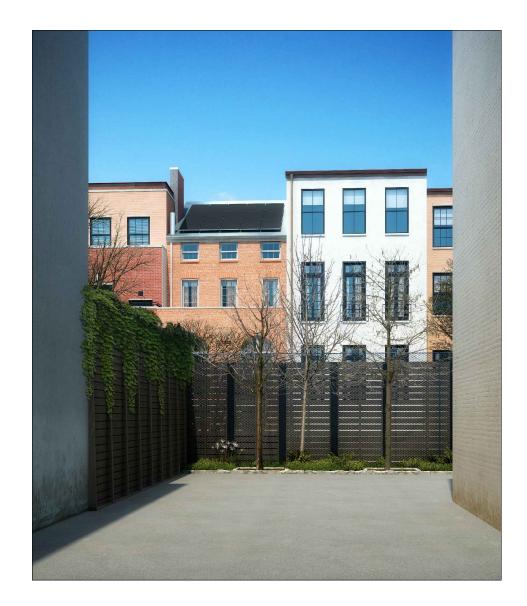



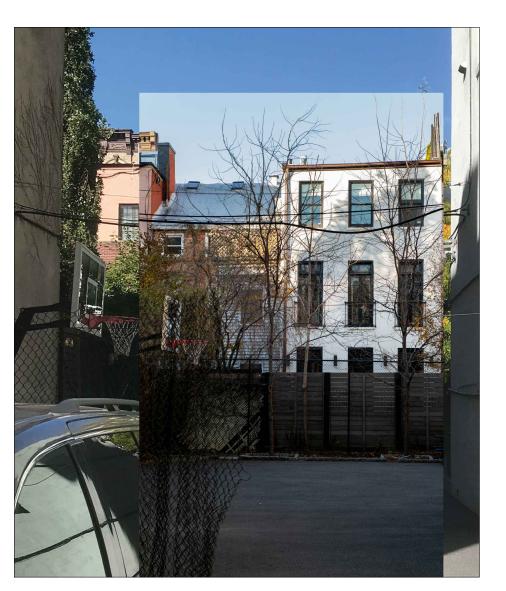

2 EXISTING SOUTH BUILDING ELEVATION FROM PUBLIC VIEW ZOOMED IN

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PROJECT:

RESIDENCE 16 LEROY ST. NEW YORK, NY

COLOR RENDERING OF PROPOSED & EXISTING REAR ADDITION PHOTO FROM PUBLIC VIEW

SEAL & SIGNATURE:

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LPC-112.00









(2) EXISTING SOUTH BUILDING ELEVATION FROM PUBLIC VIEW

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PROJECT:

RESIDENCE 16 LEROY ST. NEW YORK, NY

COLOR RENDERING OF PROPOSED & EXISTING REAR ADDITION PHOTO FROM PUBLIC VIEW

SEAL & SIGNATURE:

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	SCALE:	N.
	PROJ. NO:	
	DRAWN BY:	
	CHK BY:	
	DWG NO:	

LPC-113.00

IT SHALL BE THE RESPONSIBILITY OF THE CONTRACTOR TO ADHERE TO THE FOLLOWING

1. ALL WORK SHALL COMPLY WITH THE RULES AND REGULATIONS OF THE DIVISION OF INDUSTRIAL SAFETY AND ALL OTHER LOCAL, STATE AND FEDERAL AGENCIES AND AUTHORITIES HAVING JURISDICTION.
2. OBITAIN AND PAY FOR ALL PERMITS REQUIRED TO PERFORM THE DEMOLITION WORK AS REQUIRED BY ALL AGENCIES AND AUTHORITIES HAVING JURISDICTION.
3. OBTAIN AND PAY FOR LI BABILITY INSURANCE POLICY THAT NAMES AND HOLDS HARMLESS THE BUILDING OWNER. AND ITS AGENTS FOR ANY ISSUE ARISING DIRECTLY THE CONTRACTOR OR HIS AGENTS IN BECARDS TO THE PREMISES.


DEMOLITION. I TO ALL FINISHES IN PUBLIC AREAS ALONG THE DIRECT ROUTE OF THE CONSTRUCTION DEBRIS REMOVAL INCLUDING BUT NO LIMITED TO

APPROVED PLANS.

21. THE CONTRACTOR SHALL NOT PERFORM ANY CHANNELING OF THE STRUCTURAL SLABS OR BEAMS AND NO EXTERIOR WALL PENETRATIONS SHALL BE PERMITTED.

22. ALL DEMOLITION SHALL BE CONDUCTED WITH HAND TOOLS ONLY. PNEUMATIC TOOLS ARE NOT PERMITTED ON THE PROJECT.



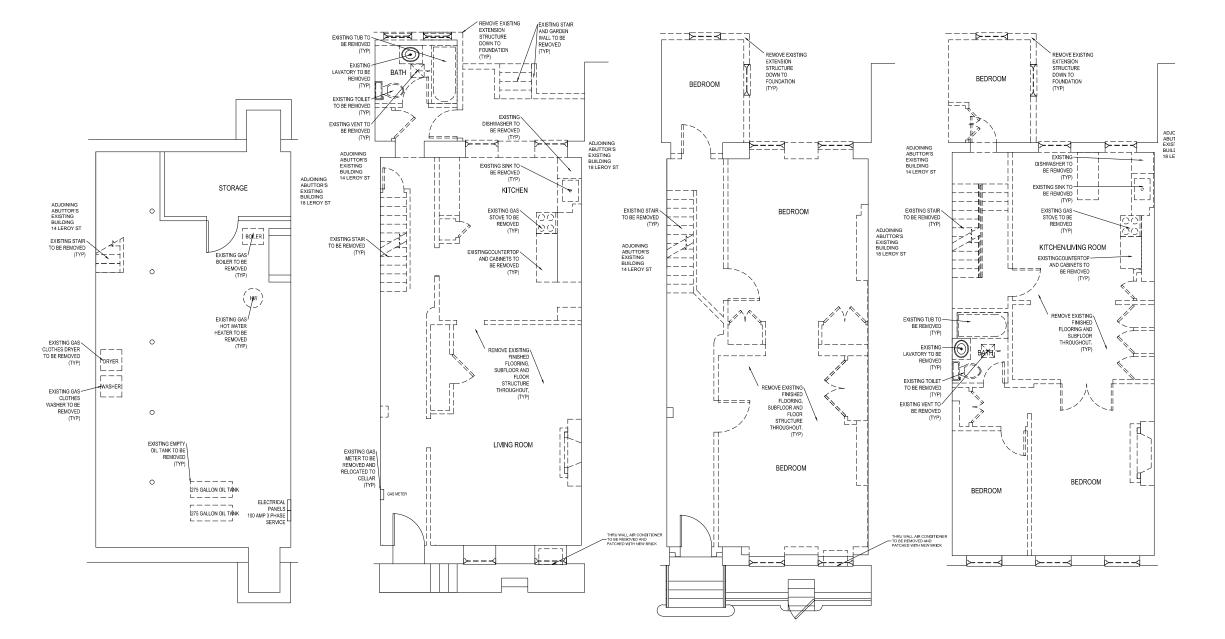


CELLAR FLOOR DEMOLITION PLAN







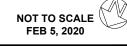

PROJECT:

RESIDENCE 16 LEROY ST. NEW YORK, NY

CELLAR, BASEMENT, 1ST & 2ND FLOOR **DEMOLITION PLANS** 

SEAL & SIGNATURE:	DATE:	4/11/2019
	SCALE:	1/4"=1'-0"
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### DEMOLITION NOTES:

IT SHALL BE THE RESPONSIBILITY OF THE CONTRACTOR TO ADHERE TO THE FOLLOWING

- IT SHALL BETHE RESPONSIBILITY OF THE CONTRACTOR TO ADHERE TO THE FOLLOWING:

  ALL WORK SHALL COMPLY WITH THE RILES AND REQULATIONS OF THE DIVISION OF INDUSTRIAL SAFETY AND ALL OTHER LOCAL, STATE AND FEDERAL AGENCIES AND ALTHORITIES HAWNO, JURISDICTION.

  AUTHORITIES HAWNO, JURISDICTION.

  A OBTAIN AND PAY FOR ALL PERMITS SEQUIRED TO PERFORM THE DEMOLITION WORK AS REQUIRED BY ALL AGENCIES AND AUTHORITIES HAWNO, JURISDICTION.

  3. DISTAIN AND PAY FOR LIABILITY INSURANCE POLICY THAT NAMES AND HOLDS HARMLESS THE BUILDING OWNER. AND ITS AGENTS FOR ANY ISSUE ARISING DIRECTLY FROM THE CONTRACTOR OR HIS AGENTS IN RECARDS TO THE PREMISES.

  4. THE CONTRACTOR SHALL PROVIDE A PULL TIME SITE SUPERVISOR FOR THE DURATION OF THE DEMOLITION.

  5. THE CONTRACTOR SHALL NOTIFY THE BUILDING MANAGEMENT AND ADJACENT REGISTRATION OF THE DEMOLITION.

  6. THE CONTRACTOR SHALL NOTIFY AND COORDINATE WITH THE BUILDING MANAGEMENT AND ADJACENT REGISTRATION OF THE MEMOLITION.

  7. REMOVE AND SALVAGE DEBRIS FROM THE SITE AS IT ACCUMULATES. DO NOT STOKE SELL BURN OR OTHERWISE DISPOSE OF DEBRIS ON THE SITE. REMOVE ALL AND DEBRIS AT ALL ITMES ALL MATERIALS SHALL BE DISPOSED OF IN A LICEAL MANNER. SOOT DEBRIS FOR RECVOLUTION TO THE EVITENT POSSIBLE.

  8. CONTRACTOR SHALL DOORDINATE WITH ALL CITY OF NEW YORK REQUIREMENTS FOR THE PROTECTION OF PERSONS, PROPERTIES, TRAFFIC CONTRACTOR SHALL DOORDINATE AND BE RESPONSIBLE FOR ALL CITY OF NEW YORK REQUIREMENTS FOR THE PROTECTION OF PERSONS, PROPERTIES, TRAFFIC CONTRACTOR SHALL COORDINATE AND BE RESPONSIBLE FOR ALL CITY OF NEW YORK REQUIREMENTS FOR THE PROTECTION OF PERSONS, PROPERTIES, TRAFFIC CONTRACTOR SHALL COORDINATE AND BE RESPONSIBLE FOR ALL CITY OF NEW YORK REQUIREMENTS FOR THE PROTECTION OF PERSONS, PROPERTIES, TRAFFIC CONTRACTOR SHALL COORDINATE AND BE RESPONSIBLE FOR ALL CITY OF NEW YORK REQUIREMENTS FOR THE PROTECTION OF PERSONS, PROPERTIES, TRAFFIC CONTRACTOR SHALL COORDINATE AND BE RESPONSIBLE FOR ALL CITY OF NEW YORK REQUIREMENTS FOR THE PROTECTION OF PERSONS, PROPERTIES, TRAFFIC CONTRACTOR SHALL C
- 9. CEASE OPERATION IF PUBLIC SAFETY OR MEMAINING STRUCTURES ARE ENUMBERED. PERFORMED.

  CONTINUED PROPERLY.

  10. IN COMPANY OF THE ENJINEER AND OWNER, VISIT THE SITE AND VERIFY THE EXTENT AND LOCATION OF SELECTIVE DEMOLITION REQUIRED PRIOR TO STARTING THE
  WORK. CAREFULLY IDENTIFY THE LIMITS OF SELECTIVE DEMOLITION. MARK INTERFACE SURFACES AS REQUIRED TO ENABLE THE WORKMEN TO ALSO IDENTIFY THE ITEMS
  TO BE REMOVED AND STORED, AS WIELL AS THE ITEMS TO BE LEFT INTACT.

  11. USE MEANS NECESSARY TO PREVENT DUST FROM BECOMING A NUISANCE TO THE PUBLIC, NEIGHBORING STRUCTURES, OR ANY OTHER WORK BEING PERFORMED.

  12. EXECUTE DEMOLITION WORK TO ENSURE THE SAFETY OF PERSONS AND ADJACENT PROPERTY AGAINST DAMAGE BY DEBRIS.

- 13. SHORE AND BRACE EXISTING CONDITIONS AS REQUIRED FOR REMOVAL OF EXISTING CONSTRUCTION OR INSTALLATION OF NEW WORK.

  14. COORDINATE THE REMOVAL, RELOCATION, REPLACEMENT, REUSE, SHUTOFF, STUB-OFF, CAPPING-OFF, OR UPGRADING OF ALL EXISTING PLUMBING, AND ELECTRICAL
- 14. COORDINATE THE REMOVAL, RELOCATION, REPLACEMENT, REUSE, SHUTOH, SI UB-UH-, LAPTING-UF-, OR UPGRAVING OF THE LOCATION AND INCOMENSATION OF THE FINISHED FLOOR, SYSTEMS.

  15. REMOVE AND DISPOSE OF CARPET, FLOOR TILE, MASTIC, ADHESIVE AND ALL OTHER FLOORING MATERIALS, IF ANY, RELATED TO OR PART OF THE FINISHED FLOOR, RIGHT OF THE FINISHED FLOOR, STATE AND INCOMENSATION OF THE FINISHED SHARE REMOVAL AND INPOSED.

  16. THE CONTRACTOR SHALL REMOVE AND LEGALLY DISPOSE OF ALL ASSESTOS CONTAINING MATERIALS AND IN DOING SO SHALL COMPLY WITH ALL APPLICABLE OSHA REGULATIONS AND ALL OTHER FEBERAL STATE AND LOCAL GUIDELINES REGARDING ASSESTOS CONTAINING MATERIAL REMOVAL AND DISPOSAL.

  17. ALL WORK SHALL NOTI MIPAC. THE REGULARDS FIRE RATINGS OF THE COLLUMNS, SEAMS, CHASES, OR OTHER FIRE RATED ELEMENTS. IF FIRE-PROOFING IS DISTURBED DURING THE DEMOLITION PHASE, IT MUST BE RESTORED TO ITS ORIGINAL CONDITION AND/OR EQUAL FIRE RATING.

  18. CONTRACTOR TO COMPLY WITH ALL DUST CONTROL AND CONSTRUCTION DEBRIS REMOVAL REQUIREMENTS SET FORTH BELOW:

  19. PROVIDE A DUST STEMOLY ALL AT AT THE EMTRANCE OF THE WITHIN THE APPRIMENT AND WET DOWN THE AREAST OF BE DEMOLISHED AS REQUIRED TO CONTAIN ALD BORN DUST DEBRIS DURING DEMOLITION.

  19. PROVIDED A DUST SEMBLY ALL HAT AT THE EMTRANCE TO THE WITHIN THE APPRIMENT AND WET DOWN THE AREAST OF BE DEMOLISHED AS REQUIRED TO CONTAIN ALD BORN DUST DEBRIS DURING DEMOLITION.

  19. PROVIDED AND THE CONTROL ALL PRINSHES IN PUBLIC AREAS ALONG THE DIRECT ROUTE OF THE CONSTRUCTION DEBRIS REMOVAL INCLUDING BUT NO LIMITED TO
- BORN DUST DEBIS DURING DEMOLITION.

  C. PROVIDE PROTECTION TO ALL FINISHES IN PUBLIC AREAS ALONG THE DIRECT ROUTE OF THE CONSTRUCTION DEBRIS REMOVAL INCLUDING BUT NO LIMITED TO
  HALLWAYS AND ELEVATORS.

  D. CONTRACTOR SHALL CLEAN ALL PUBLIC AREAS AFFECTED BY THE CONSTRUCTION INCLUDING BUT NOT LIMITED TO AREAS LOCATED ALONG THE DIRECT ROUTE OF
  THE CONSTRUCTION DEBRIS REMOVAL FROM SITE ON A DAILY BASIS.

  PIG. WHERE DEMOLITION OF EXISTING WALLS IS TO BE PREPORNED, THE STRUCTURAL INTEGRITY AND FIRE RATING OF THE BUILDING MUST NOT BE COMPROMISED.

  20. DURING CONSTRUCTION, THE SELECTED CONTRACTOR SHALL IMMEDIATELY NOTIFY THE ARCHITECT OF ANY STRUCTURAL CONDITIONS NOT IDENTIFIED ON THE
  APPROVED PLANS.
- PPROVED PLANS.
  1. THE CONTRACTOR SHALL NOT PERFORM ANY CHANNELING OF THE STRUCTURAL SLABS OR BEAMS AND NO EXTERIOR WALL PENETRATIONS SHALL BE PERMITTED.
  2. ALL DEMOLITION SHALL BE CONDUCTED WITH HAND TOOLS ONLY. PNEUMATIC TOOLS ARE NOT PERMITTED ON THE PROJECT.


### DEMOLITION KEY

= = = = EXISTING WALLS, DOORS OR FIXTURES TO BE REMOVED

EXISTING WALLS, DOORS OR FIXTURES TO REMAIN EXISTING VENT

---  $\stackrel{\triangleleft}{-}$  EXISTING WINDOWS TO BE REMOVED

■ ■ EXISTING WINDOWS TO REMAIN

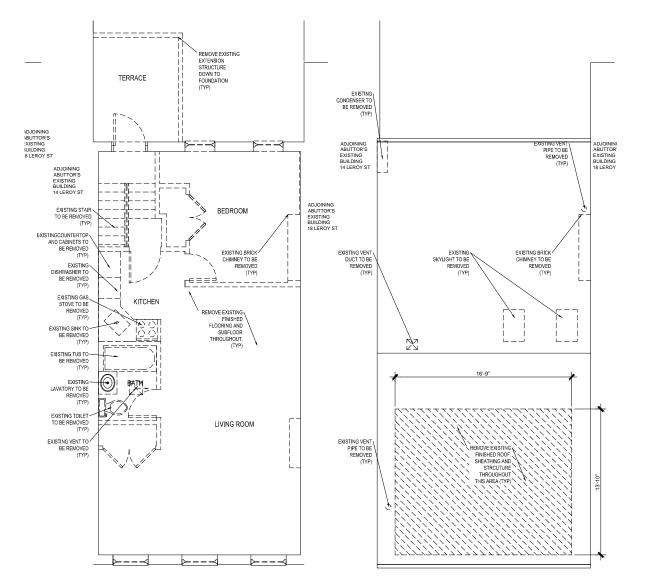







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PROJECT:

RESIDENCE 16 LEROY ST. NEW YORK, NY

3RD FLOOR & ROOF


**DEMOLITION PLANS** 

SEAL & SIGNATURE: DATE: SCALE: PROJ. NO:

1/4"=1'-0" DRAWN BY: CHK BY: DWG NO:

4/11/2019

D-110.00

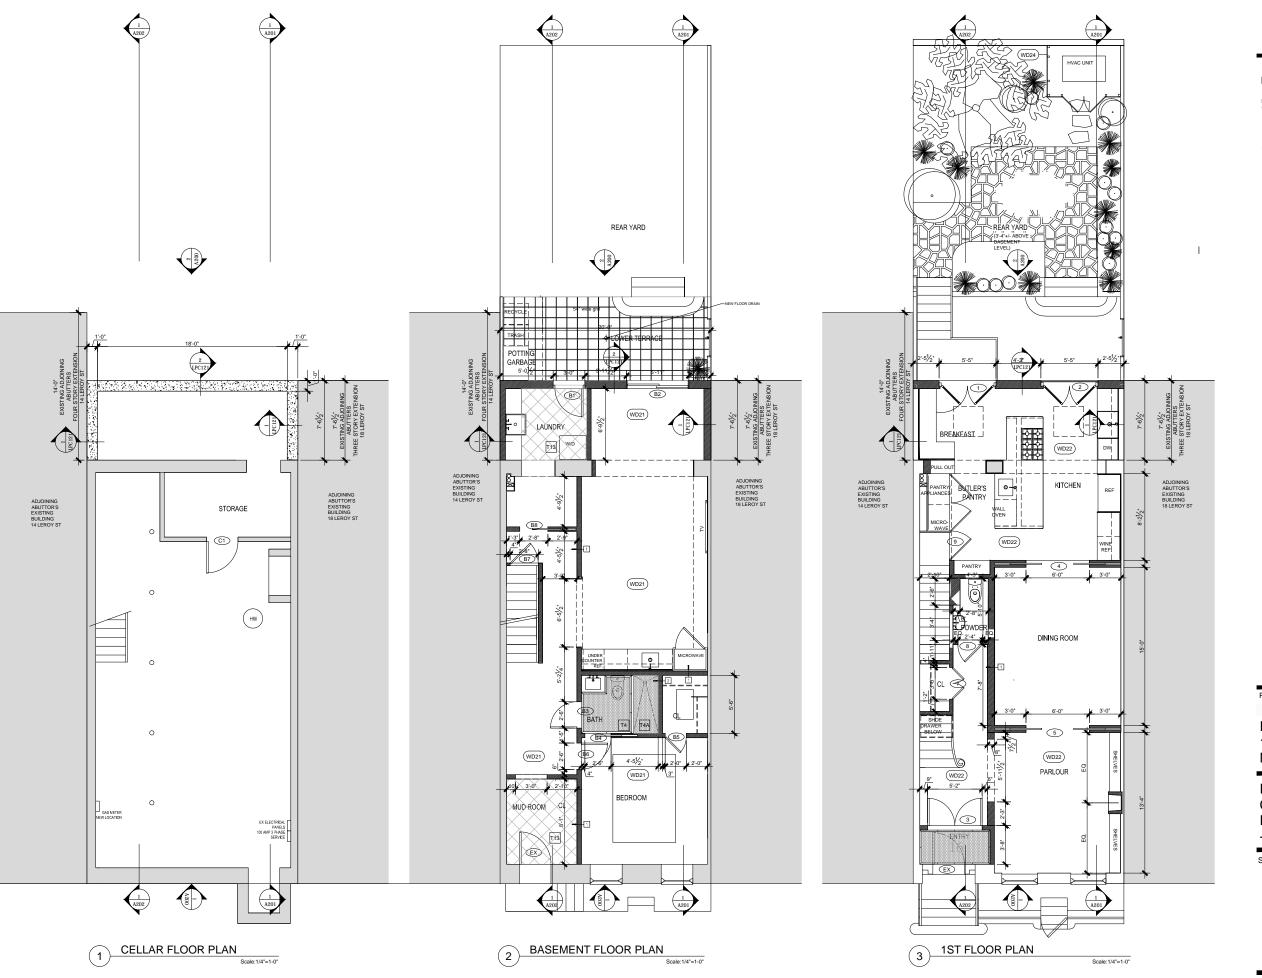

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### PLAN KEY

s

NEW SMOKE AND CARBON MONOXIDE DETECTOR


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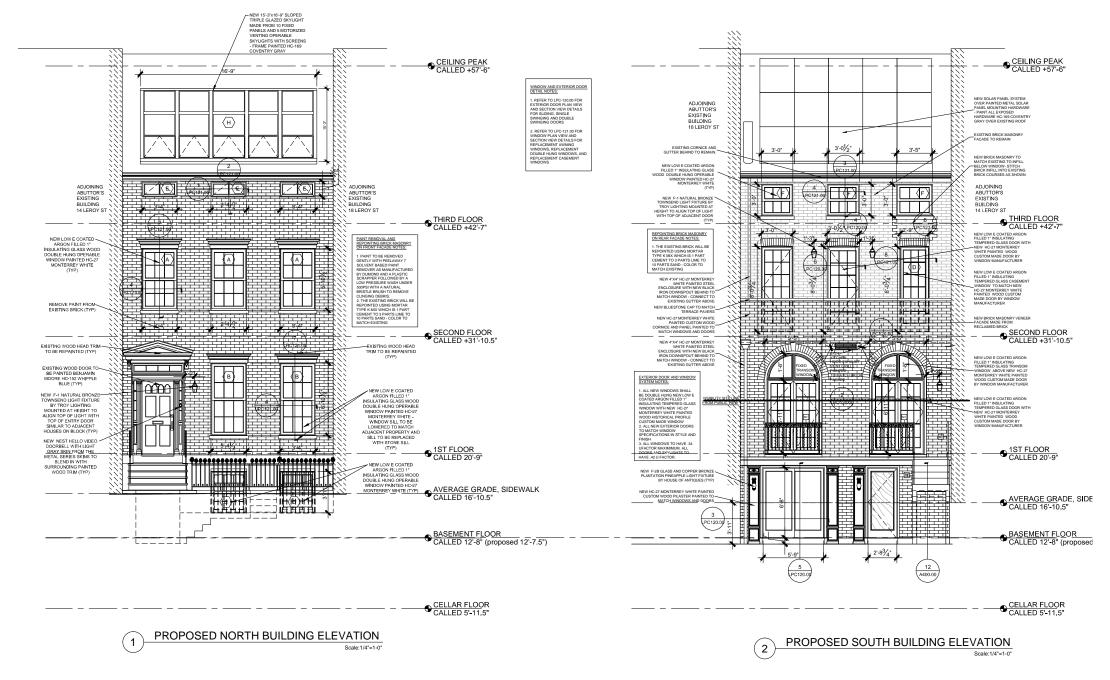
PROJECT:

RESIDENCE 16 LEROY ST. NEW YORK, NY

**PROPOSED** CELLAR, BASEMENT & 1ST FLOOR PLANS

5/19/2019 1/4"=1'-0" SEAL & SIGNATURE: DATE: SCALE: PROJ. NO: DRAWN BY: CHK BY: DWG NO: A-100.00



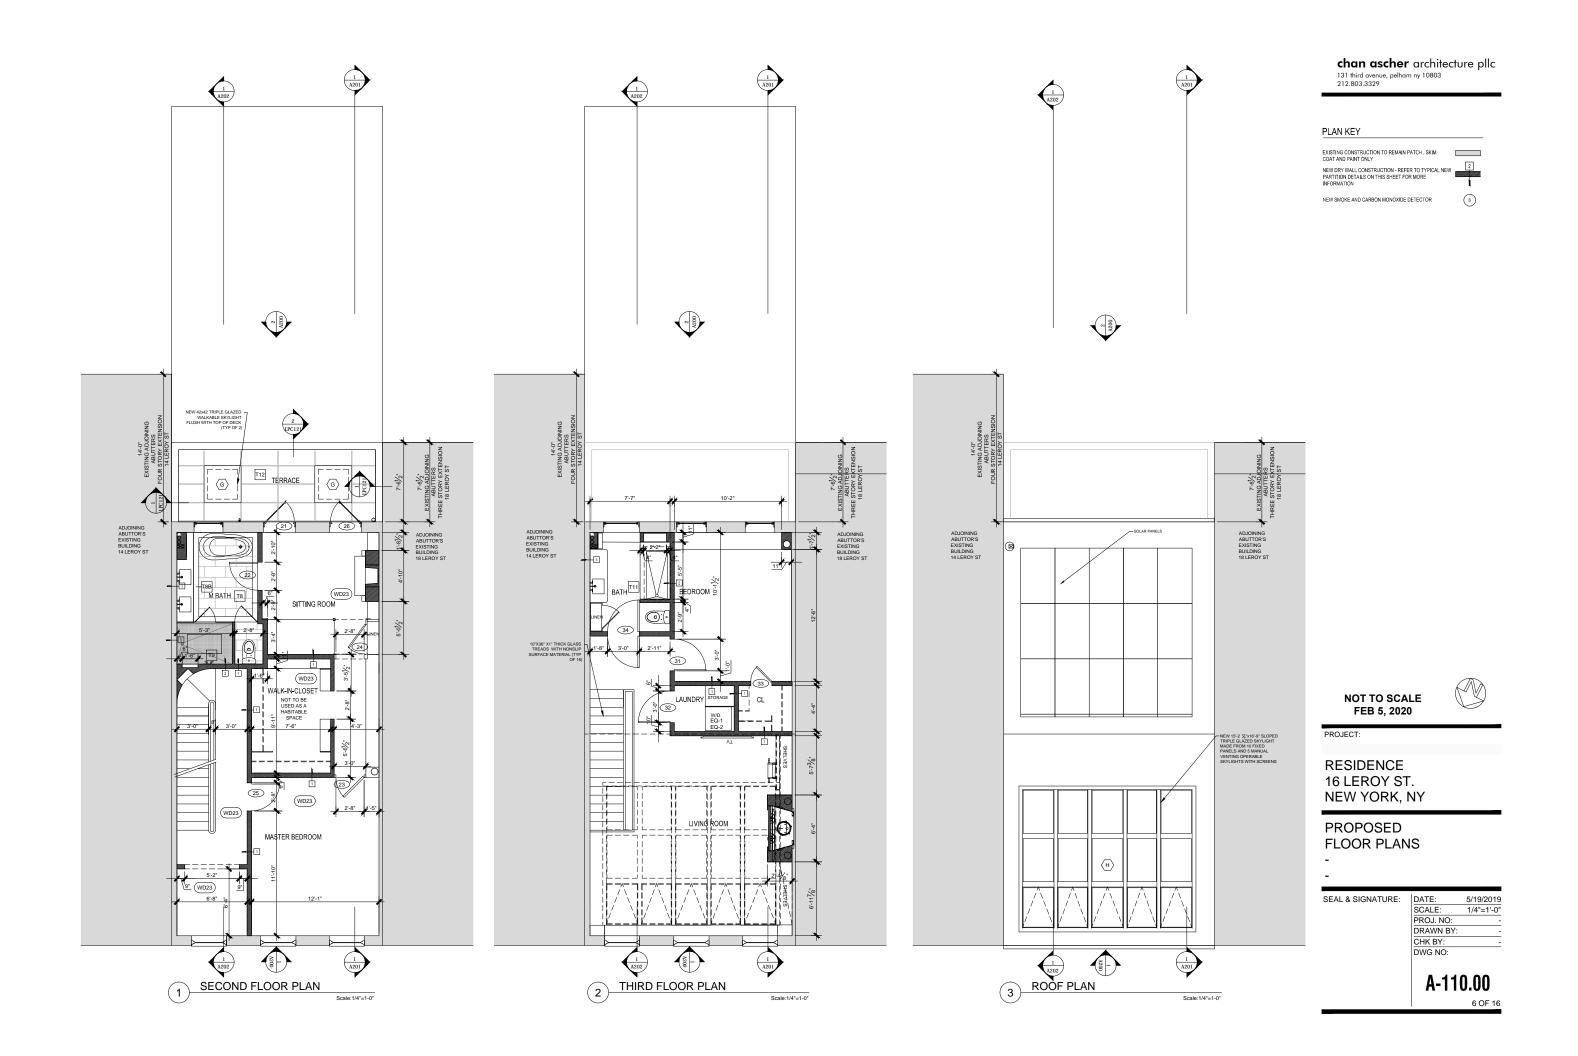

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PROJECT:

RESIDENCE 16 LEROY ST. NEW YORK, NY

PROPOSED SOUTH & NORTH BUILDING ELEVATIONS

| DATE: 5/22/2019 | SCALE: 1/4"=1"-0" | PROJ. NO: - DRAWN BY: - CHK BY: - DWG NO:

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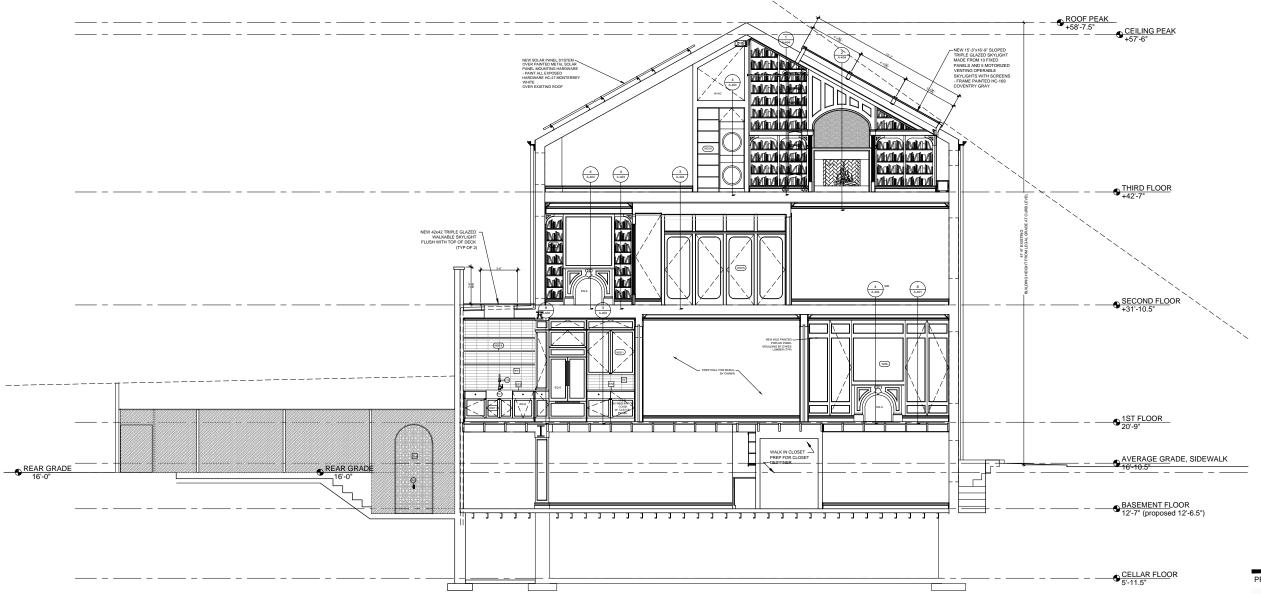
7 OF

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### INTERIOR TRIM NOTE:

REFER TO TYPICAL WALL AND INTERIOR DOOR DETAILS ON A400.00 FOR INFORMATION ON TYPICAL DOOR TRIM, CROWN AND WALL BASE AND DETAILS ON LPC-120.00 AND LPC-12.00 FOR INFORMATION ON TYPICAL WINDOW AND EXTERIOR DOOR TRIM



1 BUILDING SECTION

Scale:1/4"=1-0"

PROJECT:

RESIDENCE 16 LEROY ST. NEW YORK, NY

PROPOSED/SITE BUILDING SECTION


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A201.00

8 OF 1



**BUILDING SECTION** Scale:1/4"=1-0"

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### INTERIOR TRIM NOTE:

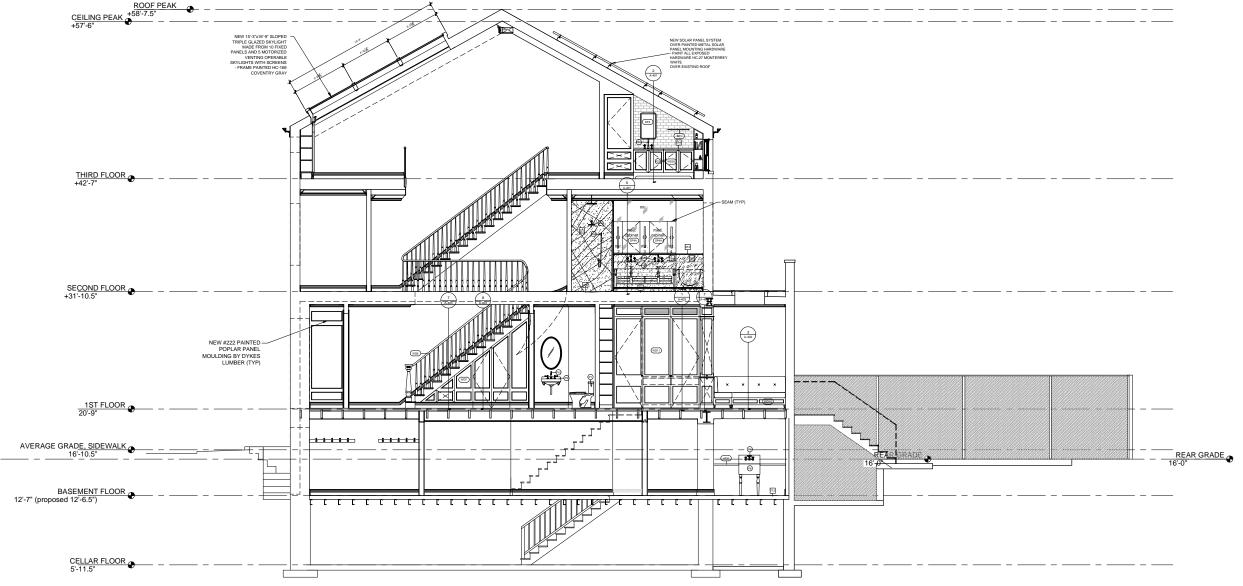REFER TO TYPICAL WALL AND INTERIOR DOOR DETAILS ON A400.00 FOR INFORMATION ON TYPICAL DOOR TRIM, CROWN AND WALL BASE AND DETAILS ON LPC-120.00 AND LPC-12.00 FOR INFORMATION ON TYPICAL WINDOW AND EXTERIOR DOOR TRIM

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# PROJECT:

RESIDENCE 16 LEROY ST. NEW YORK, NY

PROPOSED **BUILDING SECTION** 

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A202.00

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PROJECT:

RESIDENCE 16 LEROY ST. NEW YORK, NY

PROPOSED EXTENSION WALL SECTIONS

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	CHK BY:	
	DWG NO:	

A-300.00

14 OF16

CONTRACTOR TO PROVIDE WINDOW AND DOOR SCREENS AT ALL **NEW WINDOWS** 

EXISTING WINDOW, DOOR DETAILS AND JOB DESCRIPTION
WE HAVE OBSERVED THE JOB CONDITIONS AND CONCLUDED THAT THE EXISTING WINDOWS AT THE FRONT FACADE ARE NOT THE ORIGINAL WOOD WINDOWS.


THE FOLLOWING DESCRIBES THE WINDOW AND DOOR SCOPE

### FRONT FACADE


- 1 INSTALL NEW WOOD WINDOWS INTO THE EXISTING MASONRY OPENING ON THE FRONT FACADE WHERE SHOWN ON THE PROPOSED FLEVATIONS (KOLBE HERITAGE SERIES TRADITIONAL DOUBLE HUNG OR AWNING IN SELECT LOCATIONS 4 9/16" JAMB WOOD WINDOWS).
- 2. INSTALL NEW WOOD WINDOWS INTO THE ENLARGED MASONRY OPENING IN EXISTING LOCATIONS ON THE FRONT FACADE WHERE SHOWN ON THE PROPOSED ELEVATIONS (KOLBE HERITAGE SERIES TRADITIONAL DOUBLE HUNG OR AWNING IN SELECT LOCATIONS 4 9/16" JAMB WOOD WINDOWS ). 3. EXISTING WOOD FRAME AND 2" BRICK MOLD TO BE REMOVED ON ALL EXISTING WINDOWS
- 4. NEW 2" CUSTOM STYLE BRICK MOLD INCLUDED WITH THE PROPOSED WINDOWS TO MATCH IN KIND THE ORIGINAL HISTORIC WOOD BRICK MOLD FOR FRONT WINDOWS
- 5. NEW WINDOWS TO BE FACTORY PAINTED EXTERIOR FINISH. COLOR BENJAMIN MOORE HC-27 MONTERREY WHITE.

### REAR FACADE:


- I. INSTALL ONE NEW SWINGING PATIO DOOR IN EXISTING MASONRY OPENING ON THE REAR FACADE AND TWO NEW SWINGING PATIO DOORS AND ONE NEW SLIDING PATIO DOOR IN NEW MASONRY OPENINGS IN NEW REAR FACADE TWO STORY EXTENSION (KOLBE HERITAGE SERIES PATIO SWING DOORS OR SLIDING DOORS IN SELECT LOCATIONS 4 9/16" JAMB WOOD DOORS ).
- 2. INSTALL NEW WOOD WINDOWS INTO THE EXISTING MASONRY OPENING ON THE REAR FACADE WHERE SHOWN ON THE PROPOSED ELEVATIONS (KOLBE HERITAGE SERIES TRADITIONAL DOUBLE HUNG OR CASEMENT IN SELECT LOCATIONS 4 9/16" JAMB WOOD WINDOWS).
- 3. INSTALL NEW WOOD WINDOWS INTO THE NEW MASONRY OPENINGS IN NEW REAR FACADE TWO STORY EXTENSION
- WHERE SHOWN ON THE PROPOSED ELEVATIONS (KOLBE HERITAGE SERIES TRADITIONAL RADIUS TOP FIXED IN SELECT LOCATIONS 4 9/16" JAMB WOOD
- 4. NEW WINDOWS AND DOORS TO BE FACTORY PAINTED EXTERIOR FINISH, COLOR BENJAMIN MOORE, HC-27 MONTERREY WHITE.

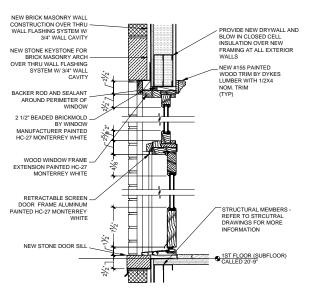

# DOUBLE SWINGING DOOR SECTION DETAIL

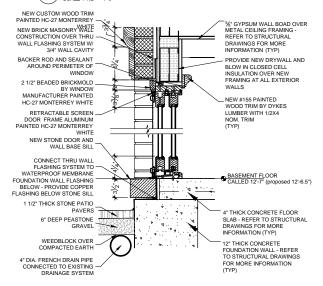

# SLIDING PATIO DOOR SECTION DETAIL

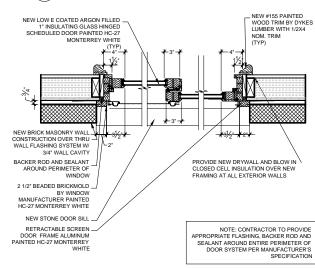


# SLIDING PATIO SILL PLAN DETAIL SCALE 1 1/2" = 1'-0"

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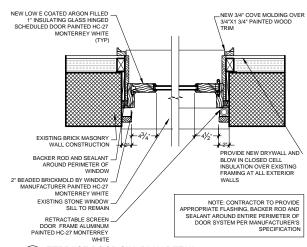
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NEW LOW E COATED ARGON FILLED 1" INSULATING GLASS HINGE SCHEDULED DOOR PAINTED HC-2 MONTERREY WHITE BACKER ROD AND SEALAN AROUND PERIMETER OF WINDOW NEW BRICK MASONRY WALL \_
CONSTRUCTION OVER THRU
WALL FLASHING SYSTEM W/
3/4" WALL CAVITY FRAMING AT ALL EXTERIOR 2 1/2" BEADED BRICKMOLD BY WINDOW MANUFACTURER PAINTED HC-27 MONTERREY NEW CUSTOM METAL RAILING \_ PAINTED HC-27 MONTERREY NEW STONE DOOK SIZE . NOTE: CONTRACTOR TO PROVIDE RETRACTABLE SCREEN. PAINTED HC-27 MONTERRE

# DOUBLE SWINGING DOOR SILL PLAN DETAIL SCALE 1 1/2" = 1'-0"



# TERRACE DOOR SECTION DETAIL

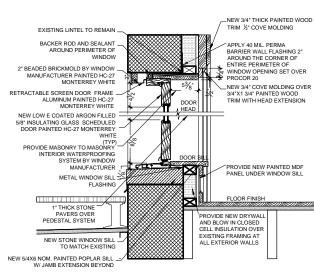

### TERRACE DOOR SILL PLAN DETAIL

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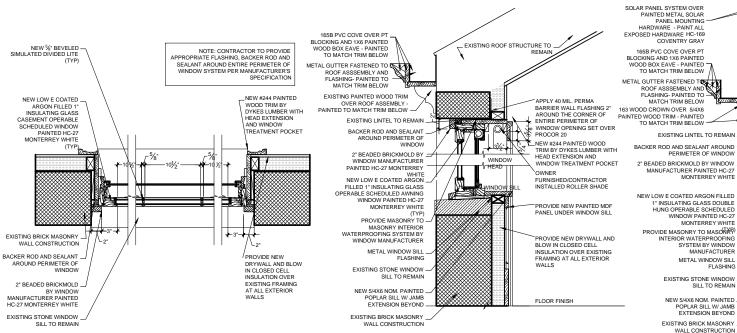
**PROPOSED EXTERIOR** DOOR DETAILS & JOB DESCRIPTION

SEAL & SIGNATURE:	DATE:	5/19/2019
	SCALE:	1-1/2"=1'-0"
	PROJ. NO:	-
	DRAWN BY:	
	CHK BY:	
	DWG NO:	

LPC-120.00

131 third avenue, pelham ny 10803

CONTRACTOR TO PROVIDE WINDOW AND DOOR SCREENS AT ALL **NEW WINDOWS** AND DOORS




# REPLACEMENT AWNING WINDOW PLAN DETAIL SCALE 1 1/2" = 1"-0"


NEW 5/8" BEVELED SIMULATED DIVIDED LITE (TYP) NEW LOW E COATED ARGON FILLED 1" INSULATING GLASS DOUBLE HUNG OPERABLE \_NEW #244 PAINTED WOOD TRIM BY DYKES LUMBER WITH HEAD EXTENSION AND WINDOW TREATMENT POCKET HC-27 MONTERREY WHITE PROVIDE NEW DRYWALL AND BLOW IN CLOSED CELL INSULATION OVER EXISTING FRAMING AT ALL EXTERIOR WALLS BACKER ROD AND SEALANT 2" BEADED BRICKMOLD BY \_ NOTE: CONTRACTOR TO PROVIDE APPROPRIATE FLASHING, BACKER ROD AND SEALANT AROUND ENTIRE PAINTED HC-27 MONTERREY EXISTING STONE WINDOW .

4 REPLACEMENT/NEW DOUBLE HUNG WINDOW PLAN DETAIL SCALE 1 1/2" = 1'-0"

# REPLACEMENT AWNING WINDOW SECTION DETAIL SCALE 1 1/2" = 1'-0'

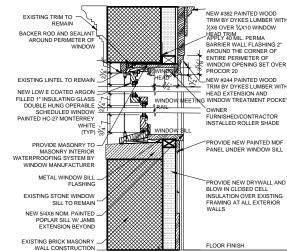

### REPLACEMENT WINDOW SECTION DETAIL 5

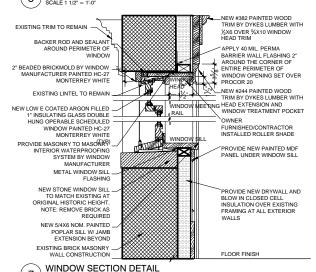

# REPLACEMENT DOUBLE HUNG WINDOW SECTION DETAIL

APPLY 40 MIL. PERMA BARRIER WALL FLASHING 2" AROUND THE CORNER OF

ENTIRE PERIMETER OF

WINDOW OPENING SET OVER PROCOR 20

FURNISHED/CONTRACTOR INSTALLED ROLLER SHADE


PANEL UNDER WINDOW SILL

INSULATION OVER EXISTING FRAMING AT ALL EXTERIOR

NDOW MEETING WINDOW TREATMENT POCKET

OWNER

PROCOR 20
HEAD THE WEST PAINTED WOOD TRIM BY DYKES LUMBER WITH HEAD EXTENSION AND WITH THE PROCESS THE PROCEDURE OF T

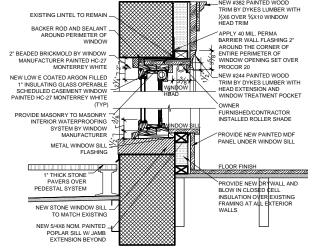

6 TALL CASEMENT WINDOW SECTION DETAIL SCALE 1 1/2" = 1'-0"

COVENTRY GRAY

MATCH TRIM BELOV

2" BEADED BRICKMOLD BY WINDOW MANUFACTURER PAINTED HC-27 MONTERREY WHITE

1" INSULATING GLASS DOUBLE HUNG OPERABLE SCHEDULED WINDOW PAINTED HC-27

PROVIDE MASONRY TO MASONRY


INTERIOR WATERPROOFING SYSTEM BY WINDOW

METAL WINDOW SILL FLASHING

EXISTING STONE WINDOW SILL TO REMAIN

NEW 5/4X6 NOM PAINTED EXTENSION BEYOND

EXISTING BRICK MASONRY WALL CONSTRUCTION \_

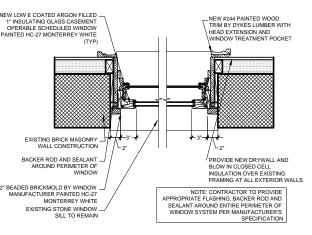

REPLACEMENT CASEMENT WINDOW PLAN DETAIL

NOT TO SCALE FEB 5, 2020

PROJECT:

RESIDENCE 16 LEROY ST. NEW YORK, NY

**PROPOSED EXTERIOR WINDOW DETAILS** 

SEAL & SIGNATURE:

DATE: 5/19/2019 SCALE: 1-1/2"=1'-0" PROJ. NO DRAWN BY: CHK BY: DWG NO:

LPC-121.00